
A-000	Cover Sheet	07/26/2023
C1	Existing Civil Plan	11/17/2022
L1	Landscape Plan	03/24/2023
L2	Streetscape	03/24/2023
L3	Roof Deck Plant Materials	03/24/2023
L4	Roof Deck Materials	03/24/2023
L5	Green Score Calculation	03/24/2023
L6	Green Score - Site Details	03/24/2023
L7	Green Score - Site Details	03/24/2023
L8	Green score - Site Details	03/24/2023
L9	Tree Protection Plan	03/24/2023
LO	Landscape Plan	03/24/2023
LR0	Roof Deck Plan	03/24/2023
C-101	Illustrative Site Plan	09/2022
C-102	Transportation Elements Plan	09/2022
C-103	Pedestrian Access Plan	09/2022
C-104	Bicycle Parking Plan	09/2022
C-105	Motor Vehicle Movement Plan	09/2022
A-010	Diagrammatic Section & Bldg Metrics	07/26/2023
A-020	Site Plan	07/26/2023
A-023	Gross Floor Area	07/26/2023

A-024	Leasable Floor Area	07/26/202
A-100	Basement Floor Plan	07/26/202
A-101	1st Floor Plan	07/26/202
A-102	2nd - 4th Floor Plans	07/26/202
A-103	Roof Plan	07/26/202
A-301	Primary Front Elevation - Broadway	07/26/202
A-302	Secondary Front Elevation-Thurston	07/26/202
A-303	Side Elevations	07/26/202
AV-1	Perspective at Broadway & Thurston	07/26/202
AV-2	Perspective at Broadway	07/26/202
AV-3	Thurston Street Perspective	07/26/202
AV-4	Proposed Rendering	07/26/202
AV-5	Proposed Rendering	07/26/202
AV-6	Proposed Aerial	07/26/202
AV-7	Proposed Aerial	07/26/202
AV-8	Shadow Study - Vernal Equinox	07/26/202
AV-9	Shadow Study - Summer Solstice	07/26/202
AV-10	Shadow Studies -Summer Solstice /Autumnal Equinox	07/26/202
AV-11	Shadow Studies -Winter Solstice /Autumnal Equinox	07/26/202
AV-12	Winter Solstice Shadow Study	07/26/202

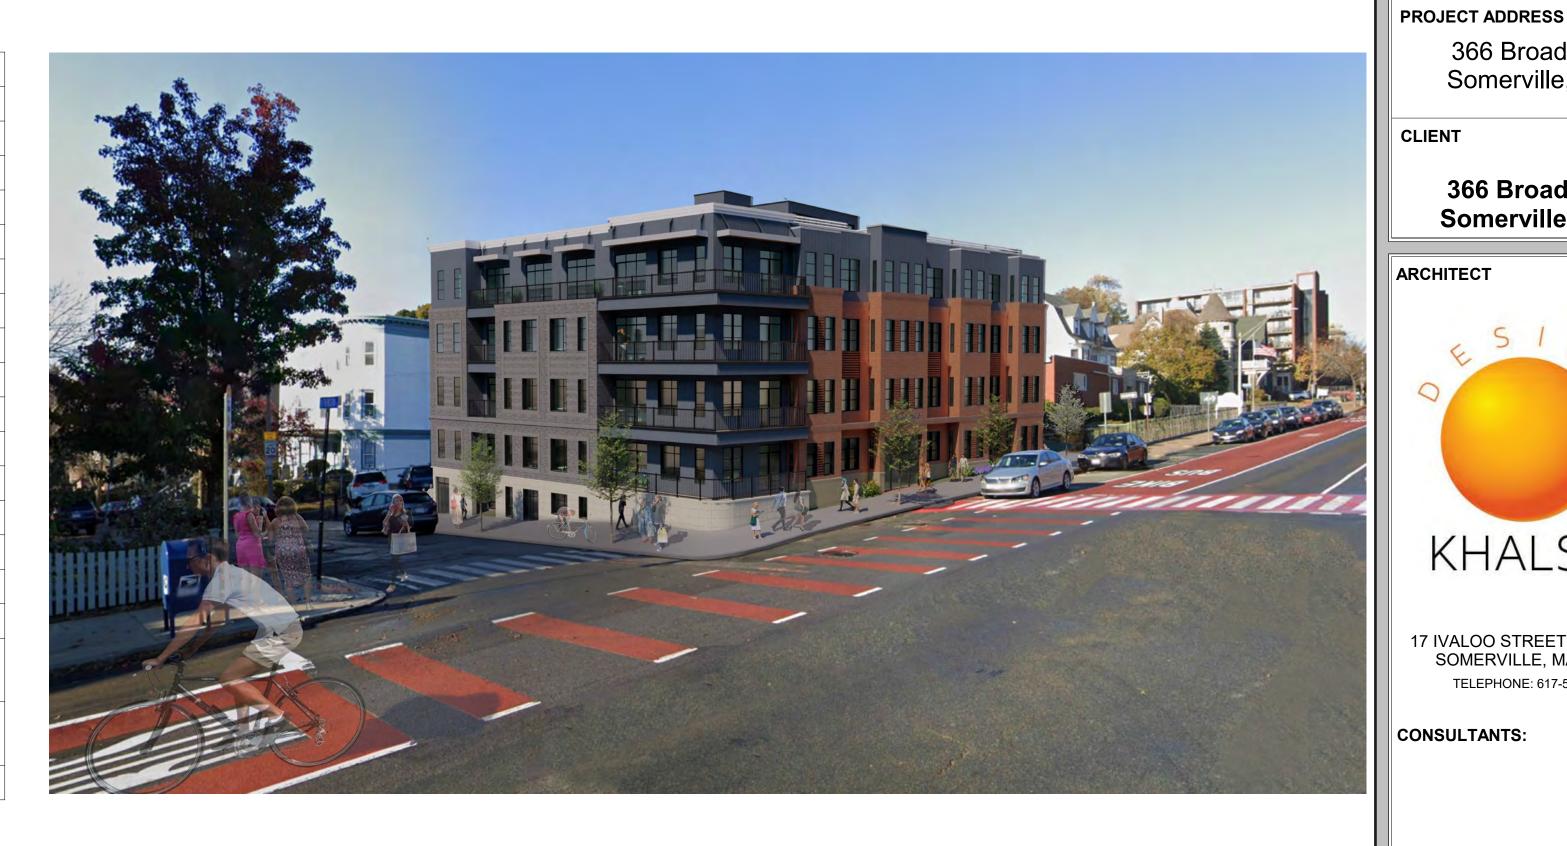

LOCUS MAP . Map 58 16 5338 BROWNING RD FAIRVIEW TER SYCAMORE TER SCALE: 1" = 60'

PROJECT: 366 BROADWAY RESIDENCES

PROJECT ADDRESS: 366 BROADWAY SOMERVILLE, MASSACHUSETTS

ARCHITECT KHALSA DESIGN INC. ADDRESS: 17 IVALOO STREET, SUITE 400 SOMERVILLE, MA 02143

LANDSCAPE ARCHITECT KHALSA DESIGN INC. ADDRESS: 318 HARVARD STREET, SUITE 25 BROOKLINE, MA 02446

CIVIL DGT ASSOCIATES ADDRESS 803 SUMMER STREET, 1ST FLOOR BOSTON, MA 02127

CLIENT

366 BROADWAY LLC

c/o EDWARD DOHERTY

200 BROADWAY, SUITE 103

LYNNFIELD, MA 01940

MOBILITY & TRAFFIC GM2 ADDRESS 10 CABOT ROAD, SUITE 101B MEDFORD, MA 02155

07/26/2023

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PROJECT NAME


366 Broadway

Residences

366 Broadway Somerville, MA

366 Broadway

Somerville LLC

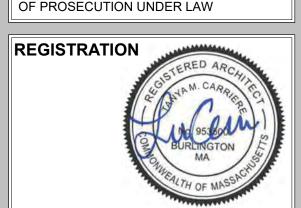


NOT FOR CONSTRUCTION		
Project number	21071	
Date	07/26/2023	
Drawn by	ERS	
Checked by	JSK	
Scale	1" = 60'-0"	

Checked by		JSK	
Scale		JSK 1" = 60'-0"	
REVISIONS			
No.	Description	Date	
1			

Cover Sheet

A-000 366 Broadway Residences

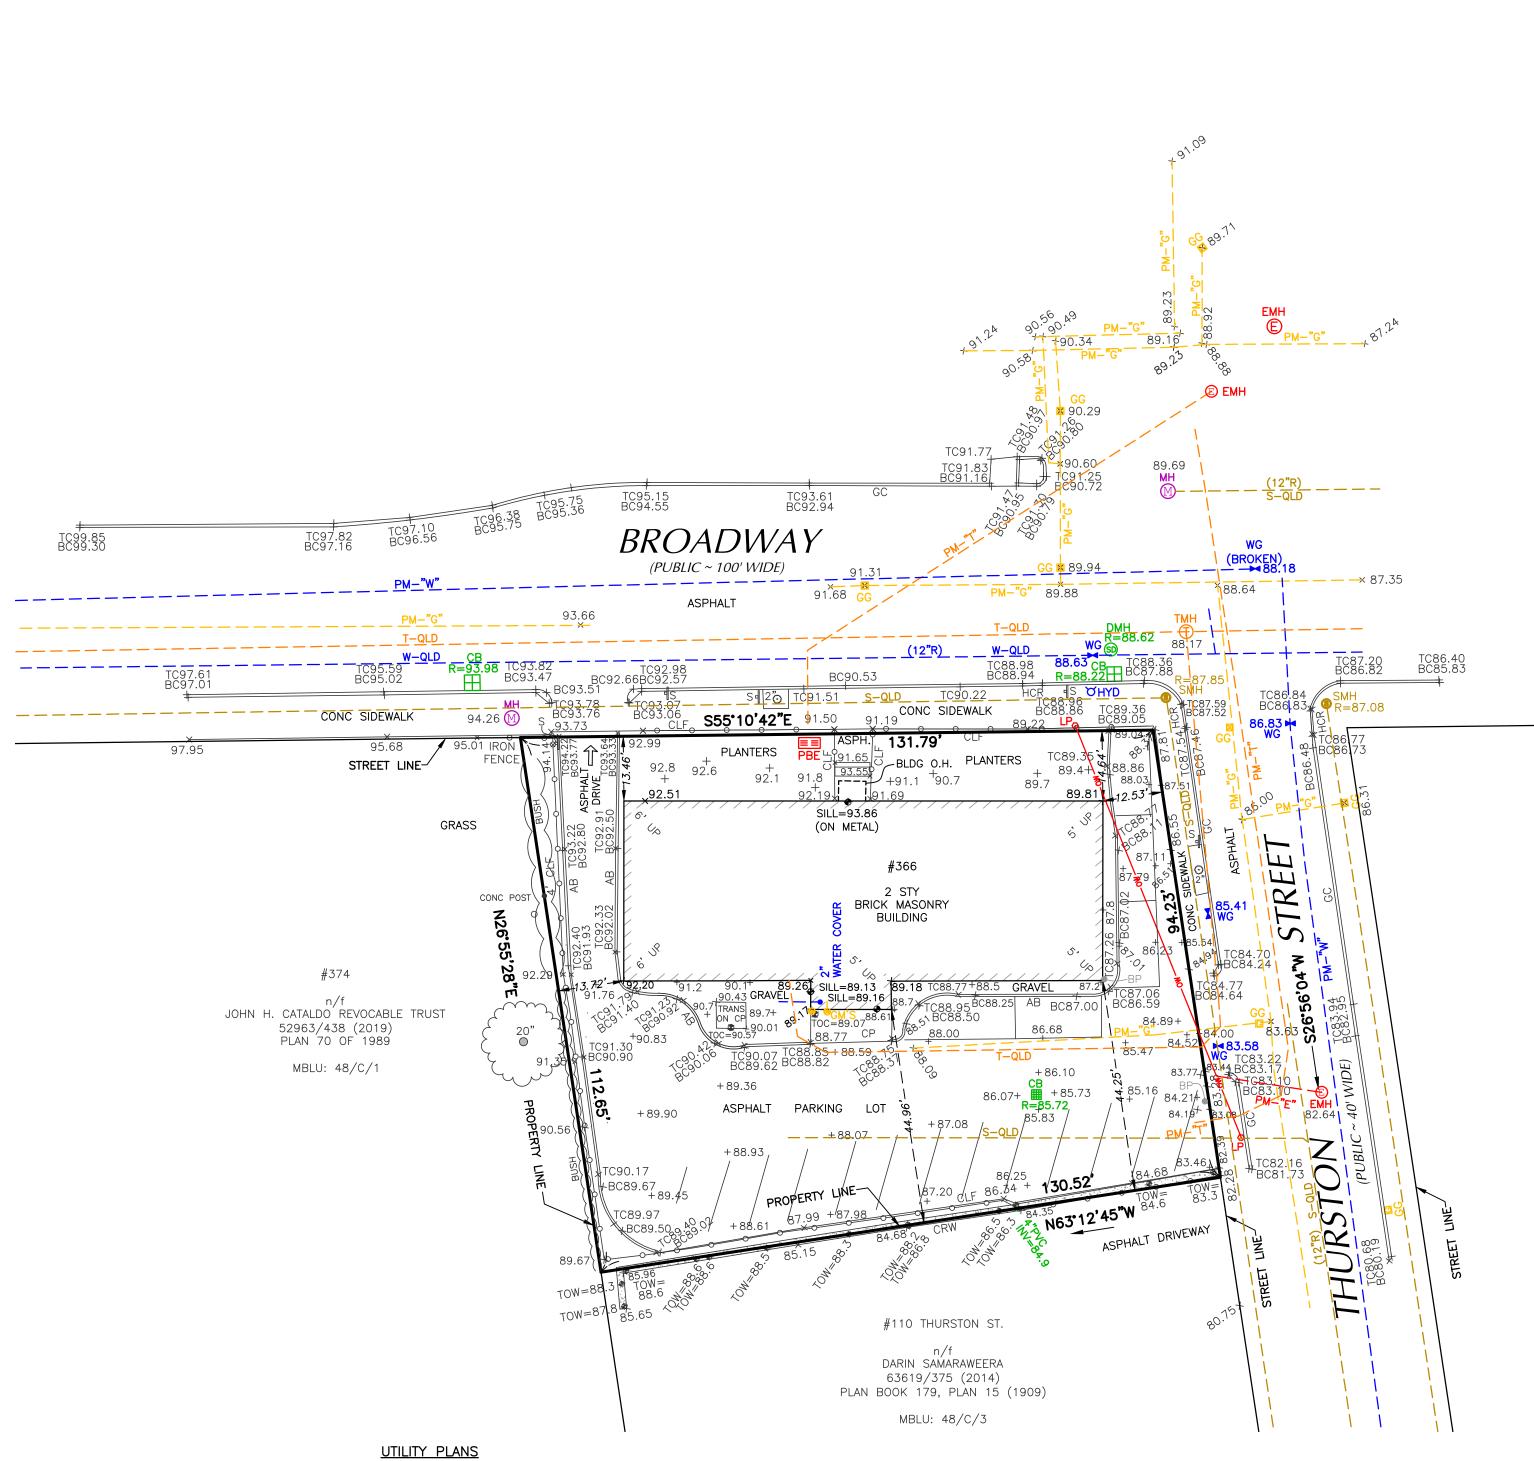

VERIZON-SOM26

CITY OF SOMERVILLE ENGINEERING DEPARTMENT

SECTION NO. 5 "WATER WORKS SYSTEM" DATED OCTOBER 1937 BROADWAY SEWER "M-01" DATED JULY 23, 1890 THURSTON STREET SEWER "J-13" DATED AUGUST 18, 1886

UTILITY NOTES

THE PRINCIPAL GUIDELINES FOR UNDERGROUND UTILITY MAPPING ARE THE AMERICAN SOCIETY OF CIVIL ENGINEERS (ASCE) CI/ASCE 38-02, STANDARD GUIDELINE FOR THE COLLECTION AND DEPICTION OF EXISTING SUBSURFACE UTILITY DATA, 2003.

UTILITY QUALITY LEVEL INFORMATION INDEX (ASCE/CI 38-02):


QUALITY LEVEL D: "QLD". UTILITY INFORMATION PLOTTED ON THE DRAWING BASED SOLELY ON RECORD INFORMATION, INDIVIDUAL RECOLLECTIONS OR THE EXISTENCE OF UTILITY SERVICE. IT SHALL BE NOTED THAT ALL INFORMATION SHOWN (OTHER THAN AT TEST HOLE LOCATIONS, SEE "QLA" BELOW), INCLUDE BUT NOT LIMITED TO UTILITY SIZE, CAPACITY, MATERIAL COMPOSITION, CONDITION OR SERVICE STATUS SHALL BE CONSIDERED "QLD" EVEN THOUGH THE UTILITY MAY BE PLOTTED AND LABELED AS "QLC" OR "QLB".

QUALITY LEVEL C: "QLC". UTILITY INFORMATION OBTAINED AS ABOVE FOR QUALITY LEVEL D, PLOTTED TO CORRELATE WITH SURFACE UTILITY FEATURES WHICH HAVE BEEN FIELD VERIFIED, SURVEY LOCATED AND ACCURATELY REDUCED ONTO THE DESIGN/CONSTRUCTION DOCUMENTS. INCLUDED IN THIS CATEGORY ARE UTILITY DEPICTIONS, WHICH IN THE PROFESSIONAL OPINION OF THE SUBSURFACE UTILITY ENGINEER REPRESENT THE MOST PROBABLE APPROXIMATE HORIZONTAL LOCATION, TYPE AND/OR EXISTENCE OF A UTILITY.

QUALITY LEVEL B: "QLB". UTILITY INFORMATION DERIVED BY ESTABLISHING THE SURFACE HORIZONTAL LOCATION OF A UTILITY USING ELECTRONIC METHODS. SAID INFORMATION IS SUBSEQUENTLY FIELD LOCATED AND ACCURATELY REDUCED ONTO THE DESIGN/CONSTRUCTION DOCUMENTS.

QUALITY LEVEL A: "QLA". UTILITY INFORMATION WHICH HAS BEEN VISUALLY VERIFIED, SURVEY LOCATED (BOTH HORIZONTALLY AND VERTICALLY) AND ACCURATELY REDUCED ONTO THE DESIGN/CONSTRUCTION DOCUMENTS. THIS IS TYPICALLY SHOWN AS A TEST HOLE OR OTHER DIMENSIONED INFORMATION.

ALL UNDERGROUND UTILITIES SHOWN HEREON ARE QUALITY LEVEL "D" (QLD) PER ASCE STANDARD 38-02 DESIGNATION UNLESS OTHERWISE NOTED. THEY ARE APPROXIMATE ONLY AND WERE COMPILED ACCORDING TO AVAILABLE RECORDS FROM THE VARIOUS COMPANIES AND PUBLIC AGENCIES. ACTUAL LOCATIONS MUST BE DETERMINED IN THE FIELD. BEFORE DESIGNING, EXCAVATING, BLASTING, INSTALLING, BACKFILLING, GRADING, PAVEMENT RESTORATION, REPAVING OR OTHER CONSTRUCTION, ALL UTILITY COMPANIES MUST BE NOTIFIED INCLUDING THOSE IN CONTROL OF UTILITIES NOT SHOWN ON THIS PLAN. SEE CHAPTER 370, ACTS OF 1963, MASSACHUSETTS. CALL "DIG-SAFE" AT 1-888-344-7233 OR DIAL 811. DGT SURVEY GROUP ASSUMES NO RESPONSIBILITY FOR DAMAGES INCURRED AS A RESULT OF UTILITIES OMITTED OR INACCURATELY SHOWN. BEFORE FUTURE CONNECTIONS, THE APPROPRIATE UTILITY ENGINEERING DEPARTMENTS MUST BE CONSULTED.

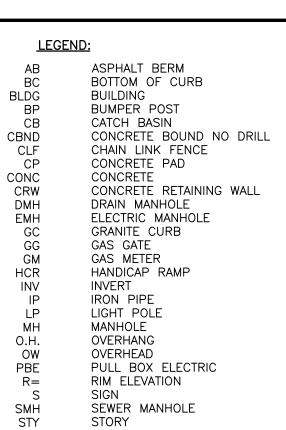

STORY
TOP OF CURB
TELEPHONE MANHOLE
TOP OF CONCRETE
TOP OF WALL
TRANSFORMER
WATER GATE

FOUND


TMH TOC

TRANS

TREE-DIAMETER AT BREAST HEIGHT

PAINT MARK FOUND ELECTRIC

PAIN MARK FOUND GAS
PAIN MARK FOUND TELEPHONE
PAIN MARK FOUND WATER

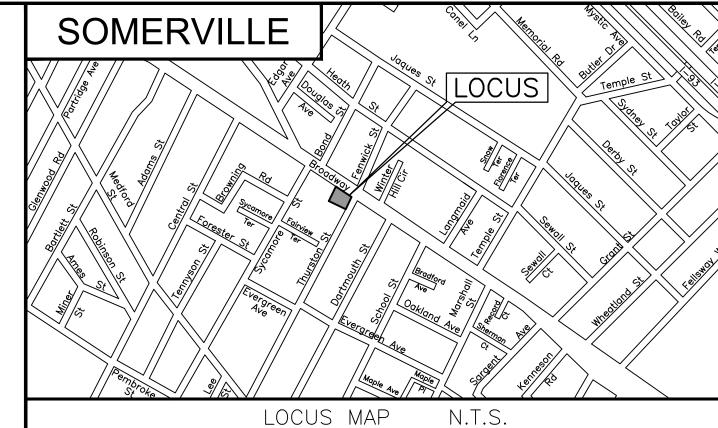

<u>REFERENCE</u>

OWNER OF RECORD: n/f 366 BROADWAY LLC 72441/78 (2019) PLAN BOOK 179, PLAN 15 (1909) AREA = 13,502 SQ. FT.

ASSESSOR MBLU: 48/C/2

PLAN REFERENCES

CITY NOTE BOOK 2, PAGES 6-8 """31, "188-195 ""40, "78-79

MIDDLESEX COUNTY REGISTRY OF DEEDS

PLAN 549 OF 2005 " 70 OF 1989

NOTES

1) FIELD SURVEY PERFORMED: SEPTEMBER 17, 24, 2021 AND NOVEMBER 17, 2022.

2) ELEVATIONS SHOWN REFER TO THE NORTH AMERICAN VERTICAL DATUM OF 1988 (NAVD 88) AS ESTABLISHED BY GPS OBSERVATIONS.

I HEREBY CERTIFY THAT:

THIS PLAN IS BASED ON AN ON-THE-GROUND SURVEY AND PRESENTS THE FACTS AS FOUND AT THE TIME OF THE SURVEY.



PROFESSIONAL LAND SURVEYOR

16-SAN-2023 DATE

> SCALE: 1" = 20' 0 10 20 40

> > 17-NOV-2022

JOB NO. S-1656.01

CRD FILE

S-1656-ALL_ NAD83_NAVD88

SHEET NO.


1 OF 1

RESEARCH: D. CLIFFORD 366 BROADWAY FIELD: K. GOMES TOPOGRAPHIC PLAN OF LAND CALCULATION: B.T. DRAFTING: SOMERVILLE, MASSACHUSETTS W.S./V.V. MIDDLESEX COUNTY CHECK: CLIFFORD, PLS PREPARED FOR: KEMS CORPORATION PROJ. MANAGER: B. TALEB PREPARED BY:

Surveying & Engineering

Framingham • Boston • Worcester
803 SUMMER STREET, 1ST FLOOR, BOSTON, MA 02127
617.275.0541 www.DGTassociates.com

BY: DESCRIPTION: DATE: REV: 0
PLAN NO.: S-1656 01TP

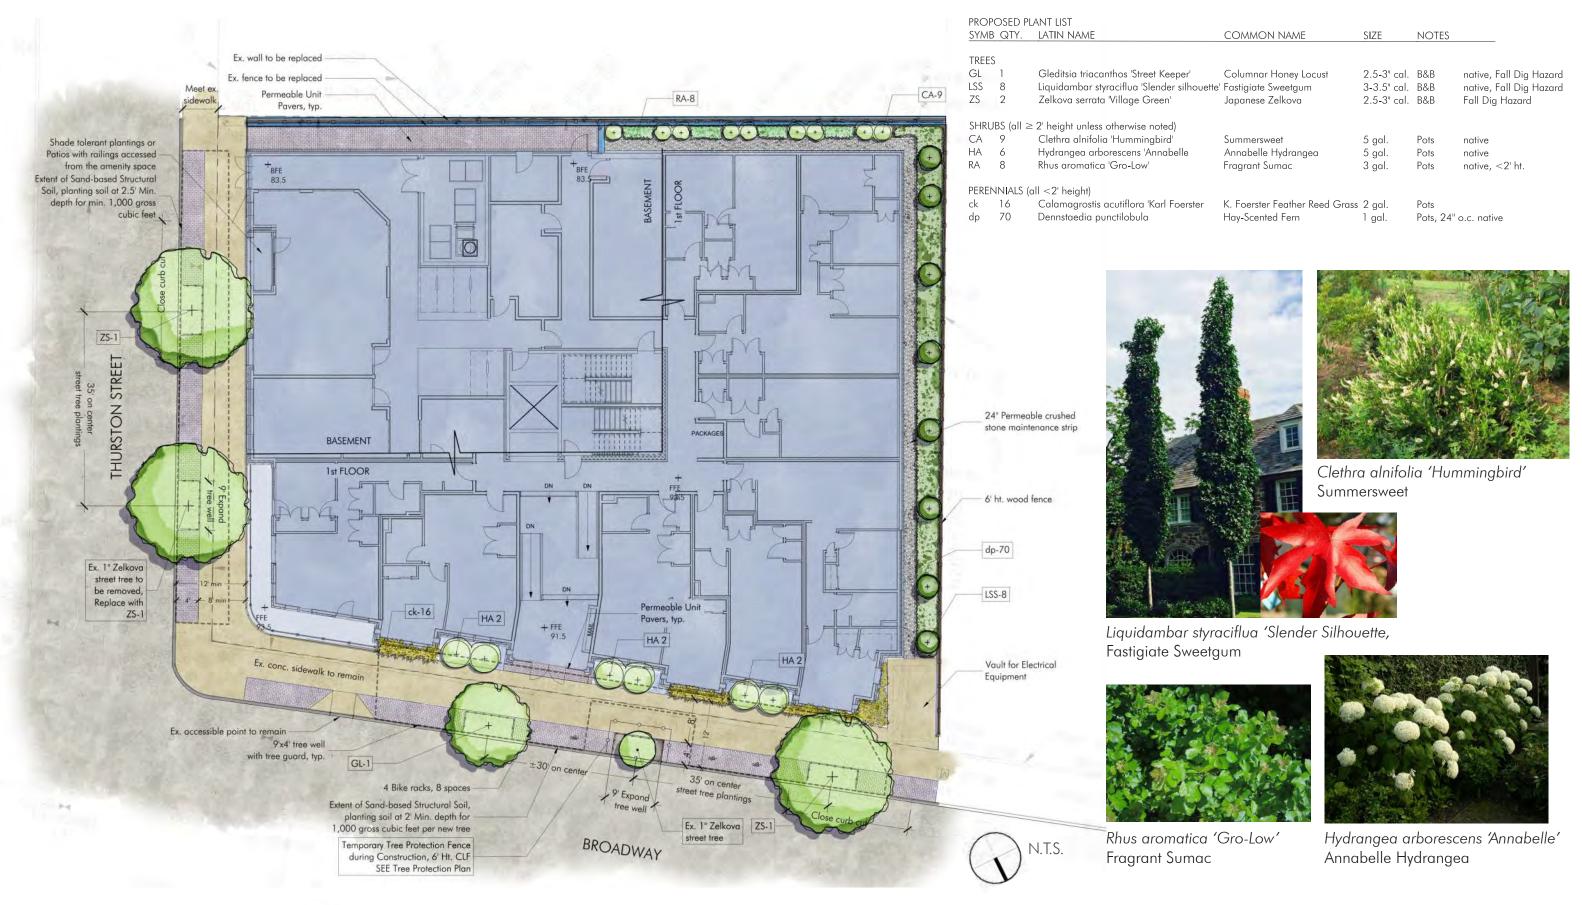







Existing Zelkova serrata 'Village Green' (Broadway)



Zelkova serrata 'Village Green' Japanese Zelkova



Tree trench with permeable pavers






Tree guard for protecting street tree plantings





Permeable Unit Pavers, Eco-Priora by Unilock OR approved equal

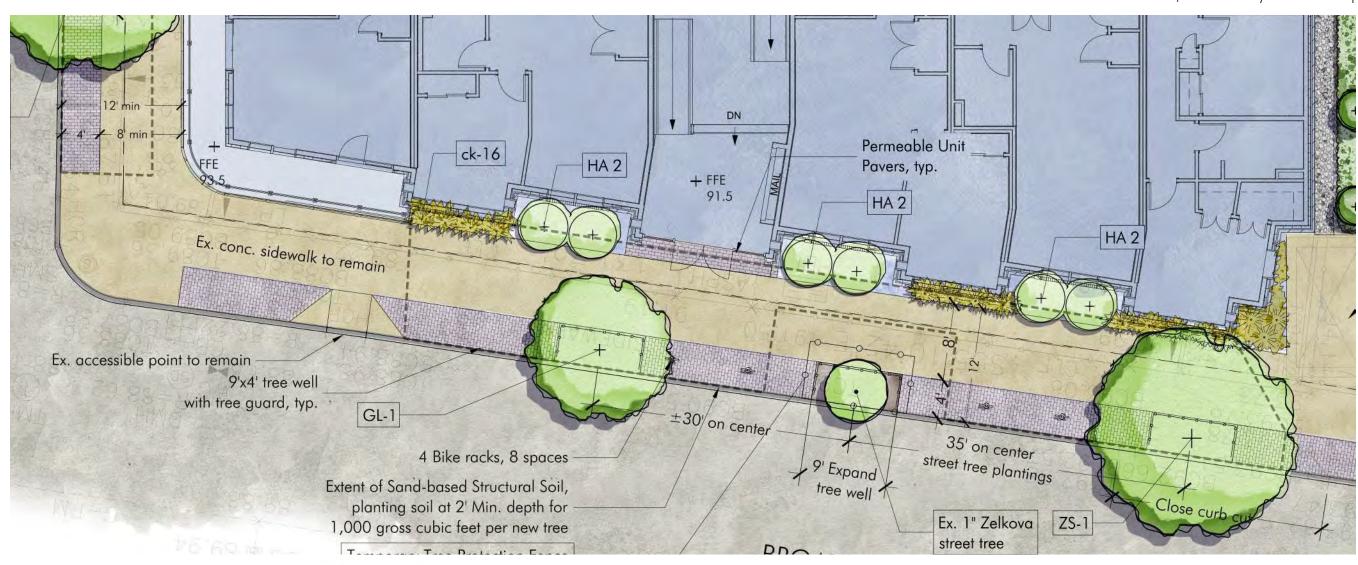




Somerville City-Standard Visitor Bike Rack with City Icon, Hoop by Dero OR approved equal







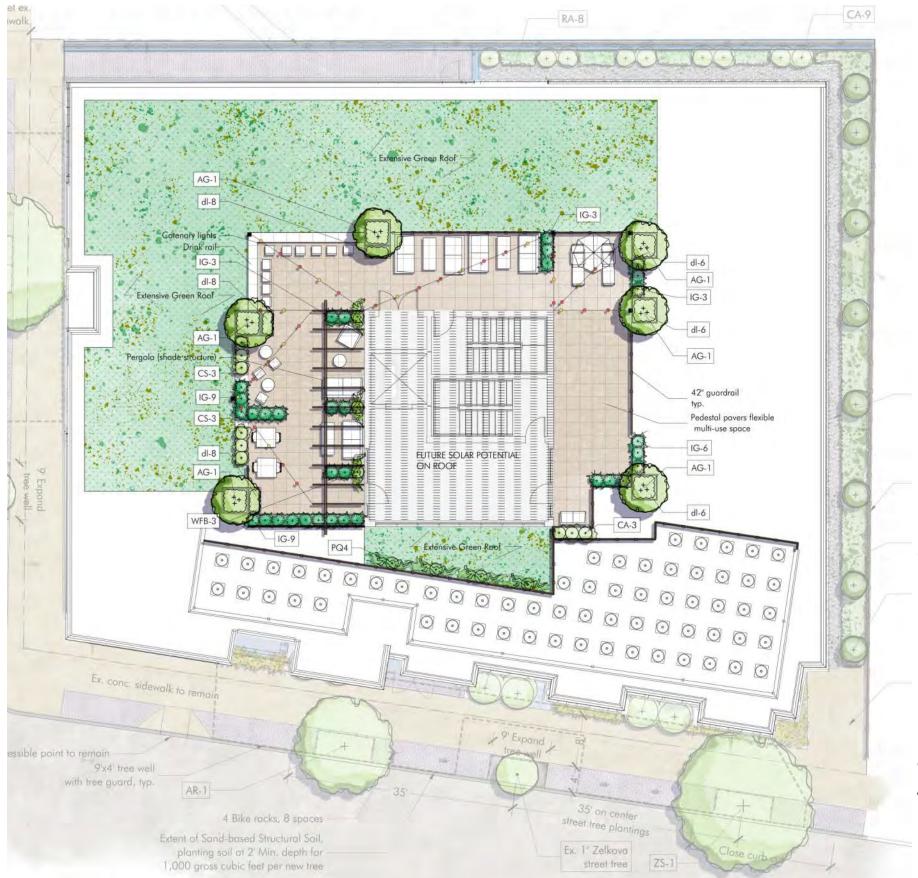

PROPOSED PLANT LIST

SYMB QTY. LATIN NAME COMMON NAME SIZE NOTES

SHRUBS (all $\geq 2'$ height)

AG Amelanchier x grandiflora 'Autumn Brilliance' Serviceberry 2-2.5" Cal. B&B multi-stem CA 3 Clethra alnifolia 'Hummingbird' Summersweet 5 gal. Pots native CS 6 Cornus sericea 'Arctic Fire' Red Twig Dogwood 3 gal. Pots native IG 30 llex glabra 'Gem Box' Dwarf Inkberry 3 gal. Pots native PQ Parthenocissus quinquefolia Virginia Creeper 3 gal. Pots native American Wisteria-lavender blue 5 gal. WFB 3 Wisteria frutescens 'Blue Moon' Pots

PERENNIALS (all <2' height)

dl 42 Dianthus 'Lionheart'

Pink Lionheart Dianthus

1 qt

Pots native



War of the law of Company of the laboratory of t

llex glabra 'Gem Box' Dwarf Inkberry






Cornus sericea 'Arctic Fire' Red Twig Dogwood



Clethra alnifolia 'Hummingbird' Summersweet

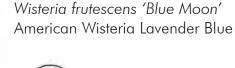









REVISED: MARCH 24, 2023

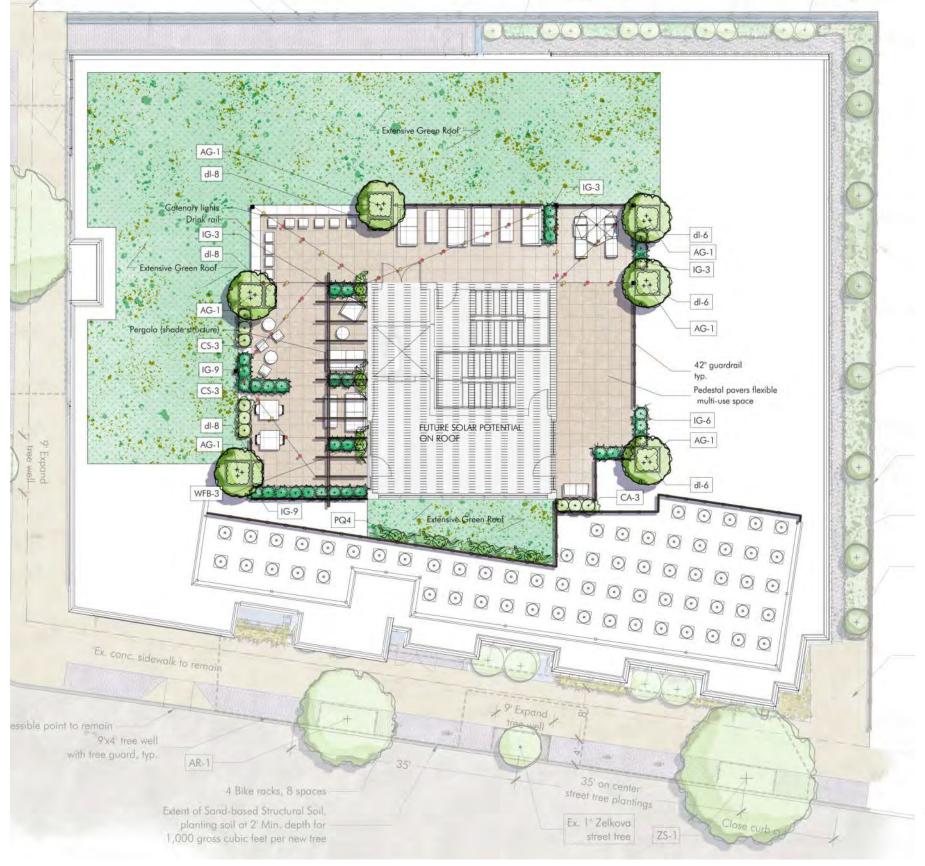





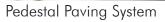





Extensive Greenroof System with Sedum Pergola, shade structure



Catenary Lights









Somerville Green Score: 366 BROADWAY

Area or Number

13,495

Soils	
Landscaped area with a soil depth less than 24 inches	0
Landscaped area with a soil depth equal to or greater than 24 inches	835
Pervious Paving with 6 to 24 inches of subsurface soil or gravel	295
Pervious Paving with more than 24 inches of subsurface soil or gravel	310
Groundcovers	
Turf grass, mulch, and inorganic surfacing materials	0
Plants	
Vegetation less than two (2) feet tall at maturity	470
Vegetation at least two (2) feet tall at maturity	15
Trees	
Small Tree	0
Large Tree	8
Preserved Tree	0
Engineered Landscape	
Vegetated Wall	
Rain gardens, bioswales, and stormwater planters	
Green Roof with up to 6" of growth medium	
Green Roof with 6"-10" of growth medium	2940
Green Roof of 10"-24" growth medium	
Green Roof of over 24" growth medium	N/A

Sq Ft Credit	Multiplier	Weighted Area	Score Value	% of Score
				1
actual sq ft	0.3	0	0.000	0%
actual sq ft	0.6	501	0.037	12%
actual sq ft	0.2	59	0.004	1%
actual sq ft	0.5	155	0.011	4%
				ı
actual sq ft	0.1	0	0.000	0%
actual sq ft	0.2	94	0.007	2%
12	0.3	54	0.004	1%
				•
50	0.6	0	0.000	0%
450	0.6	2160	0.160	51%
65	0.8	0	0.000	0%
actual sq ft	0.1	0	0.000	0%
actual sq ft	1.0	0	0.000	0%
actual sq ft	0.1	0	0.000	0%
actual sq ft	0.4	1176	0.087	28%
actual sq ft	0.6	0	0.000	0%
Calcula	N/A			


Green Score =

0.311

Required Score: Target Score: Actual Green Score:

Green Score District Requirements				
NR & UR	MR3 & MR4	MR5, MR6, & HR	FAB, CC, CB, CI	
0.35	0.25	0.20	0.20	
0.40	0.3	0.25	-	
0.311	0.311	0.311	0.311	

KEY PLAN: AT GRADE

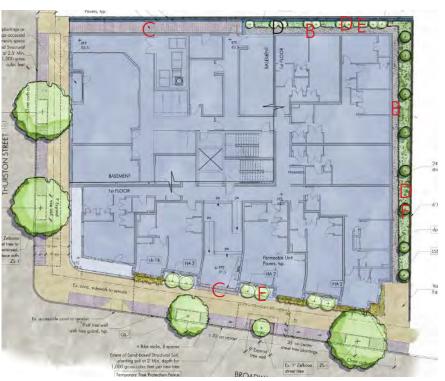


KEY PLAN: ROOF DECK







TYPICAL PLANT (TREE OR SHRUB) DETAIL

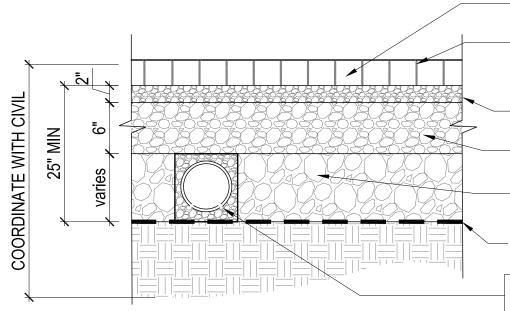

Permeable concrete unit pavers


permeable joint opening aggregate; filled with $\frac{1}{8}$ " open graded crushed, angular stone; (ASTM #8) 2" Leveling Course open graded FG stone (ASTM #8) Base Course $\frac{3}{4}$ "-1" open graded stone no fines (ASTM #57) Reservoir Course I $\frac{1}{2}$ "-3" open graded stone no fines (ASTM #2) Geotextile soil separation, see specification

pvc underdrain pipe; location as shown on Civil drawings, install if infiltration is less than 0.5 in./hr. typ. if shown in Civil drawing


Notes:

- Edge restraints vary see plan.
- All aggregate material shall be crushed, angular stone and free of fines.
- Compact subsoil with a California bearing ratio (cbr) of less than 5% as directed by a professional engineer.
- Surface slope shall be a minimum of 1% and a maximum of 5%.
- Install pvc underdrain pipe where infiltration rate of subsoil is less than 0.5 in./hr. size as directed by a professional engineer.
- Never build permeable pavements on organic clay soils of high plasticity and/or peat, mulch, soils with high organic content.
- Maintain a minimum distance of 2' between bottom of permeable base and water table.
- The minimum aggregate thicknesses are after compaction.



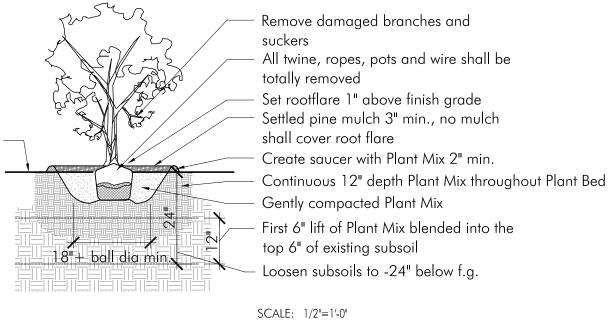

PERVIOUS CRUSHED STONE MAINTENANCE EDGE

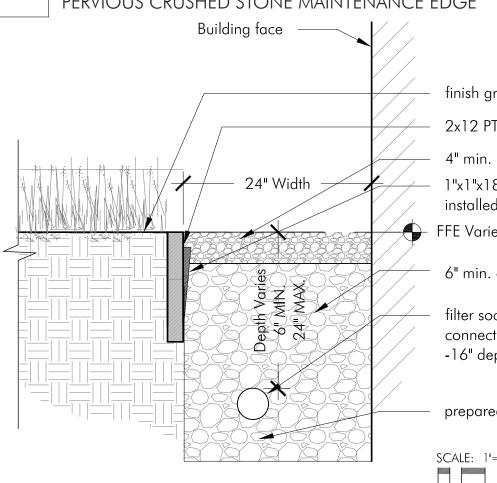

finish grade plant bed

2x12 PT wood edge, staked 24" o.c. and every corner/end

4" min. depth riverstone (1.5-2" rounded riverstone)

1"x1"x18" PT wooden stake with tapered end, installed every 24" o.c.


舟 FFE Varies, See Grading Plan

6" min. depth of $\frac{3}{4}$ " crushed stone (where no perf. pipe)

filter sock wrapped, 4" perf. pipe at sunken conditions, connect to stormwater system, see civil eng. plans,

-16" depth, extend crushed stone below


prepared free-draining backfill below

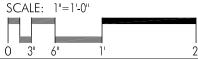






LIGHTWEIGHT PLANTER

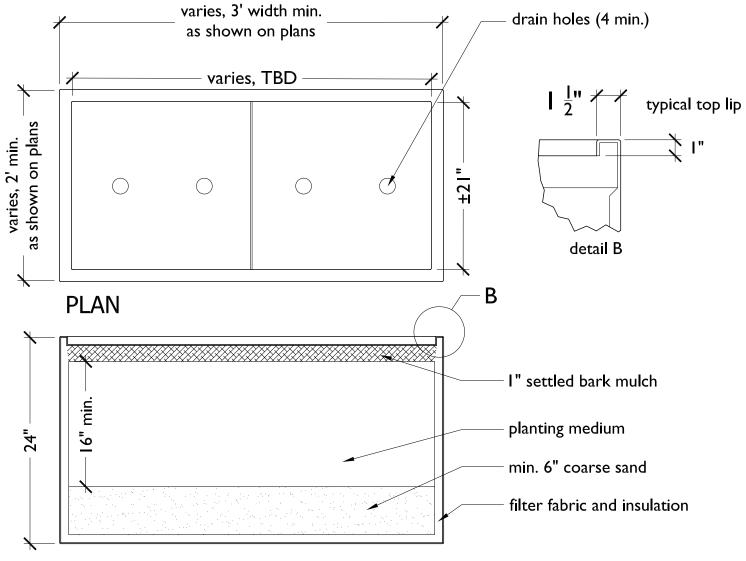


SECTION

Note:

- Wilshire Planter by Tournesol
- Provide 4 drain holes.
- Provide I" insulation on interior walls and bottom (with drain holes). Align holes for clear drainage.
- Filter fabric shall extend to -2" from top lip.
- Color and texture shall be approved by LA
- See Specification

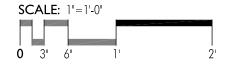

EXTENSIVE GREEN ROOF DETAIL

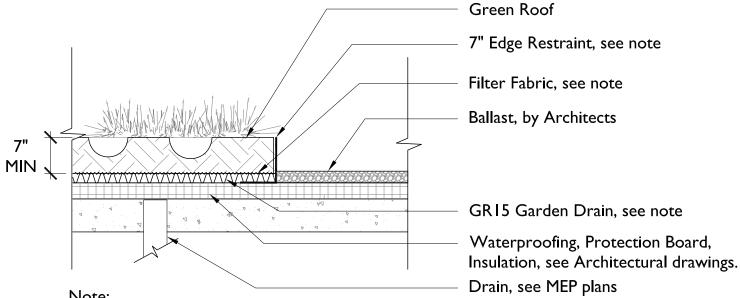


- Note:
- Sedum Sod by Hydrotech or similiar
- Edge Restraint by Permaloc
- Drainage Mat by Hydrotech GR-15 or similiar





TREE PROTECTION DETAIL


TYPICAL Existing Tree to be Protected, typ. ALIGN WITH DRIP LINE AND/OR AS SHOWN ON PLAN NOTES: Post spacing a maximum of 6' on center Minimum four posts per tree Adjust location and depth of posts to <u>PLAN</u> avoid tree roots See additional notes below.

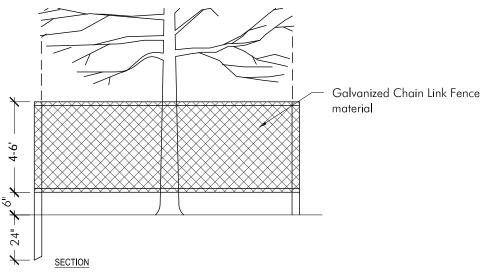

- 1. Installed tree protection must be in place prior to any work (including demolition), and approved by landscape architect. tree protection to remain in place throughout construction, remove for final landscape treatment, after approval by landscape
- 2. Adjust location of tree protection within tree dripline only when necessary to perform work
- 3. Stockpiling of soils, storing of materials, parking of vehicles or location of temporary structures shall not occur at any time within the dripline of trees to remain.
- 4. All work within drip line must be done by

N.T.S

NEW STREET TREE PLANTING WITH STRUCTURAL SOILS DETAIL

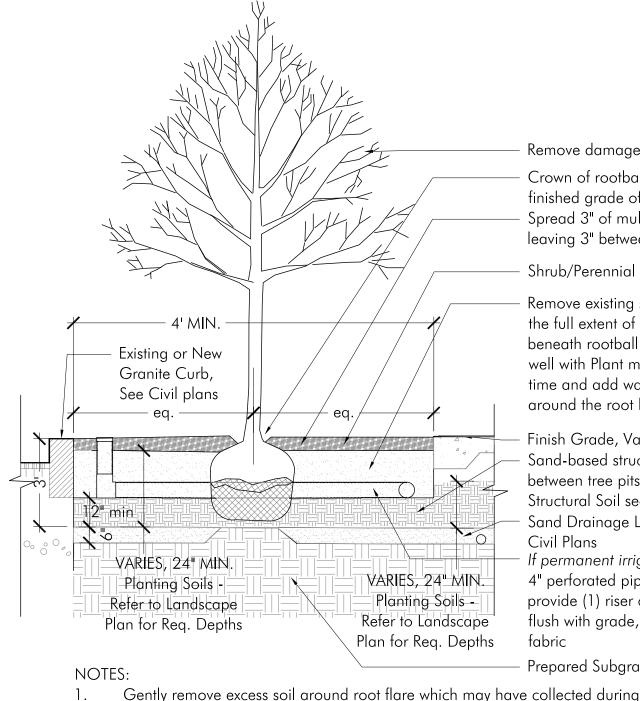

tree spading/B+B operations.

Remove damaged branches and second leader(s)

Crown of rootball shall be 2" higher finished grade of sidewalk

Spread 3" of mulch to fill extent of tree well leaving 3" between mulch and root flare

Shrub/Perennial plantings, see planting plan


Remove existing soil and replace with Plant Mix to the full extent of the tree pit. Firmly compact soil beneath rootball to avoid settlement. Backfill the tree well with Plant mix, in layers not to exceed 6" at one time and add water after every layer of soil is placed around the root ball to thoroughly settle the soil.

Finish Grade, Varies, See Materials & Layout Plan Sand-based structural planting soil, continuous between tree pits, For full extent of required Structural Soil see Materials & Layout Plan Sand Drainage Layer, with drain pipe, Coord. with Civil Plans

If permanent irrigation is not provided: Continuous 4" perforated pipe around perimeter of tree well, provide (1) riser capped with black drain grate set flush with grade, wrap all components with filter fabric

Prepared Subgrade

Provide wooden stakes (3 per tree) and guy wire (rubber hose cover at trunk) in windy locations and as site conditions require, as directed by Landscape Architect.

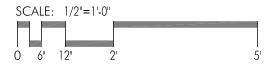







Tree Protection Prior to Site Work:


- 1. Prior to initiating site work, the Contractor shall install a 4' ht. chain link construction fence as shown on the plan to establish the Tree Protection Zone (TPZ). The Contractor shall not enter the tree protection zone with equipment, store equipment or materials within the TPZ for the duration of the construction project. The TPZ shall be maintained throughout the construction period and may only be removed as specifically directed by the Landscape Architect or Town Tree Warden.
- 2. In locations where excavation and construction work will be within the Tree Protection Zone (TPZ), the Contractor shall meet with the Landscape Architect to describe the scope of excavation or filling. Equipment shall not operate within the TPZ except as approved and directed by Landscape Architect. Typically, equipment shall set up and operated from beyond the TPZ. This may involve some adjustment in the location of chain link fencing.
- 3. A certified arborist shall be hired to cut and prune limbs and branches that may hinder construction operations or overhang the proposed building.

- 4. Install 2 to 3 inches of woodchip mulch or a blend of composted woodchips and bark mulch over the entire TPZ or 30' from the tree protection fence-- which ever is less.
- 5. The tree protection fence shall not be removed until the end of the construction of the buildings at such time as the lawn work and plantings work is initiated. The Contractor shall request and get approval to remove the tree protection fence by the Landscape
- 6. The Contractor shall set up and provide a temporary irrigation system in all the TPZ areas as directed by the Landscape Architect or Arborist. During the growing season (June 1 through October 1), the irrigation system shall supply 1" of water after any period of over 1 week when there is no natural rainfall. This added water will support vigorous tree growth allowing the tree to recover from the root damage from construction.


TREE SURVEY			
Species	Heath		
Zelkova]"	Good	To Remain + To Protect
Zelkova	1"	Poor/ Damaged	To Be Removed

*Existing DBH as measured on-site February 2022


DBH = Diameter at Breast Height = trunk diameter in inches measured $4\frac{1}{2}$ feet from the ground

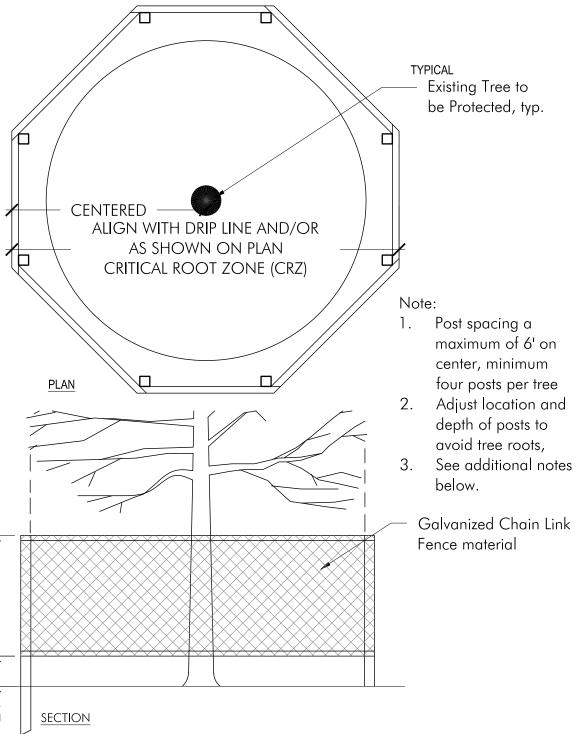

- 1. Installed tree protection must be in place prior to any work (including demolition), and approved by landscape architect. tree protection to remain in place throughout construction. remove for final landscape treatment, after approval by landscape architect.
- 2. Adjust location of tree protection within tree dripline only when necessary to perform work shown on drawings.
- 3. Stockpiling of soils, storing of materials, parking of vehicles or location of temporary structures shall not occur at any time within the dripline of trees to remain.
- 4. All work within drip line must be done by hand.

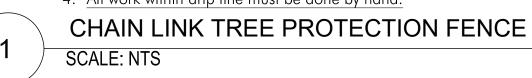



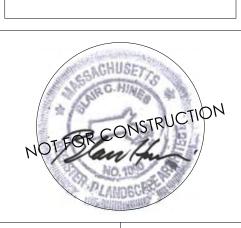

366 BROADWAY SOMERVILLE, MA	TREE PROTECTION PLAN


Project #:	Date: 03/24/2023
Drawn by: JN	Reviewed: BH
Scale: As noted	


	Revisions:

L9

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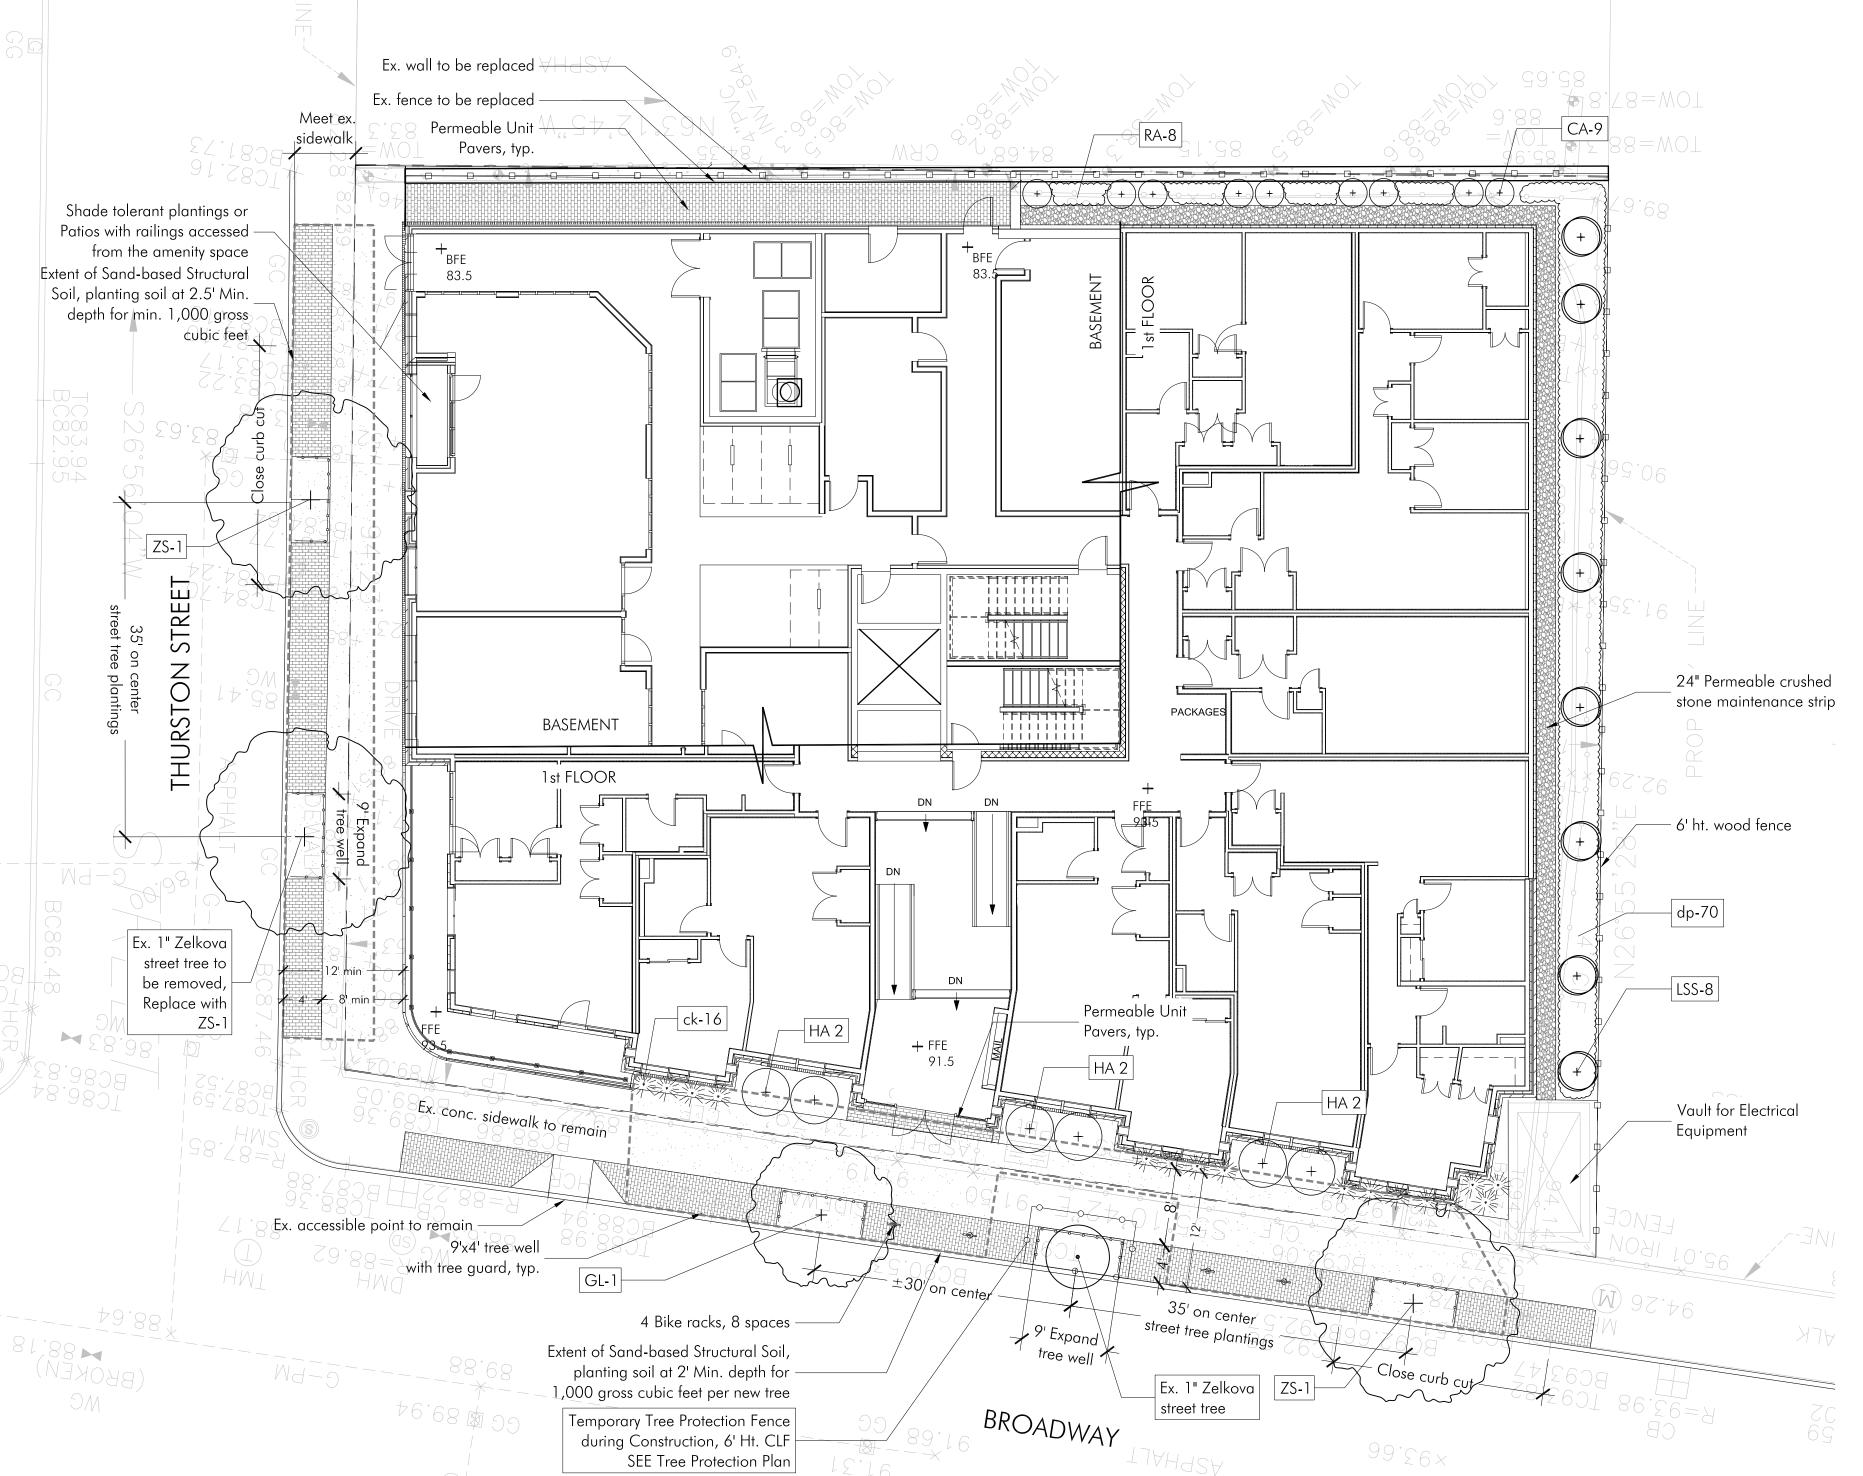


366 BROADWAY SOMERVILLE, MA	LANDSCAPE PLAN

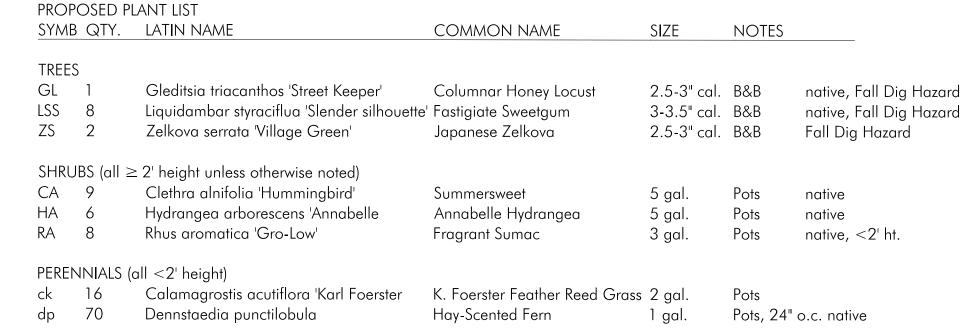Project #:	Date: 03/24/2023
Drawn by: JN	Reviewed: BH
Scale: As noted	

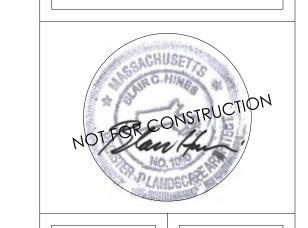Revisions:

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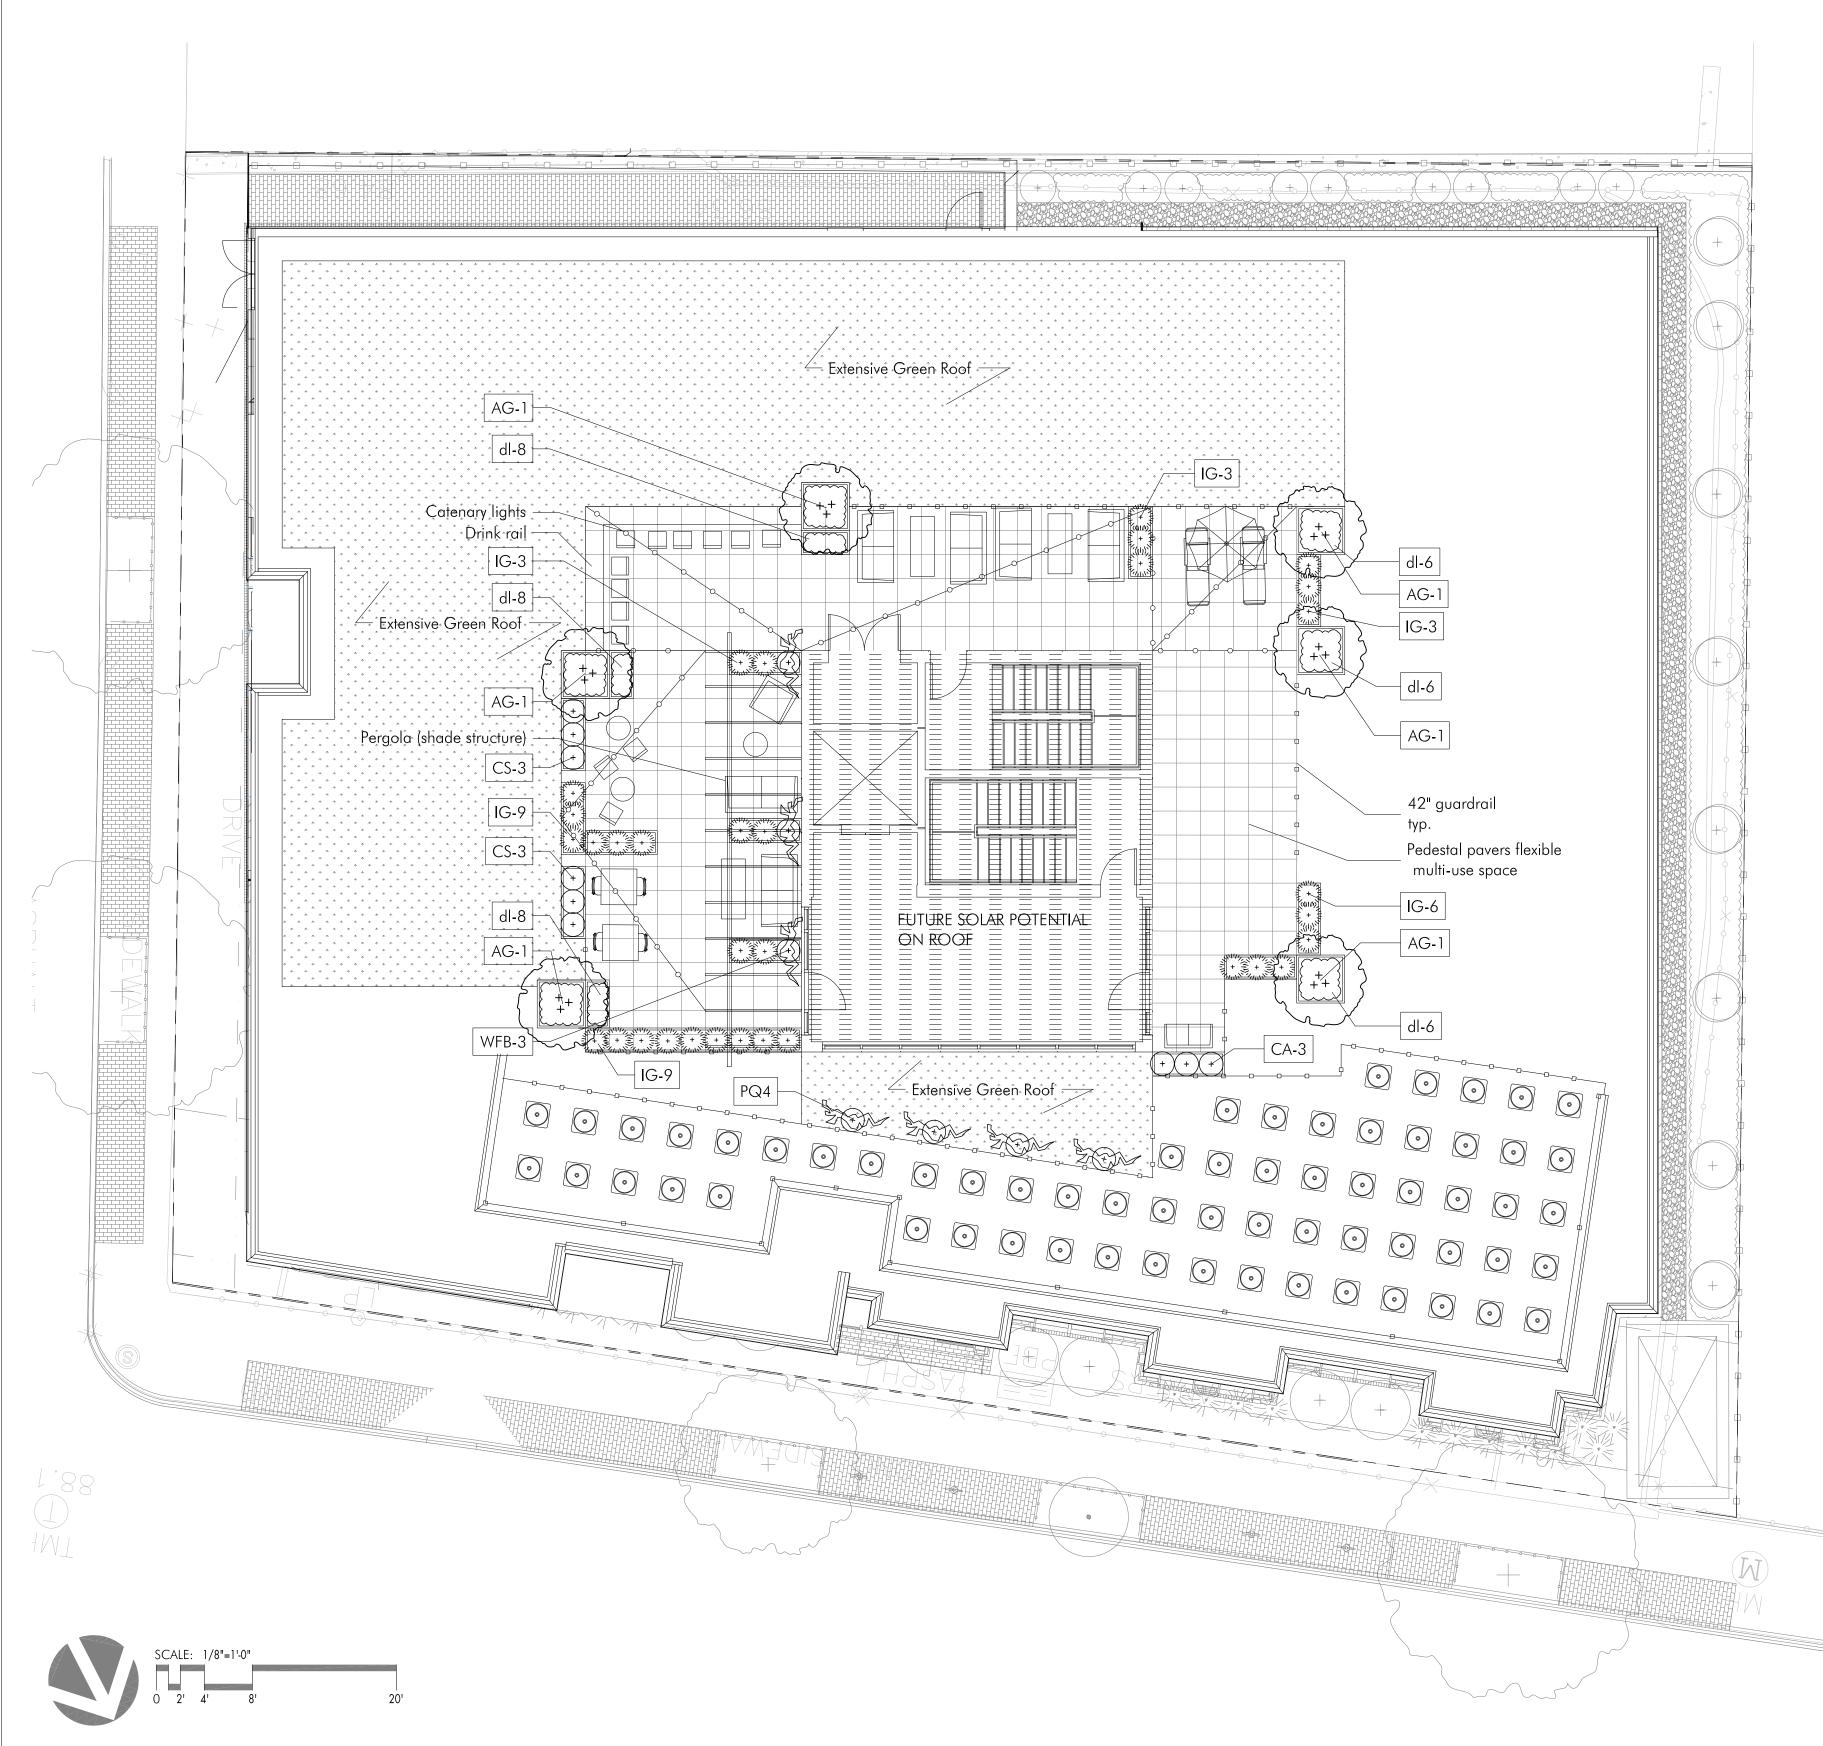









Project #:	Date: 03/23/2023
Drawn by: JN	Reviewed: BH
Scale: As noted	


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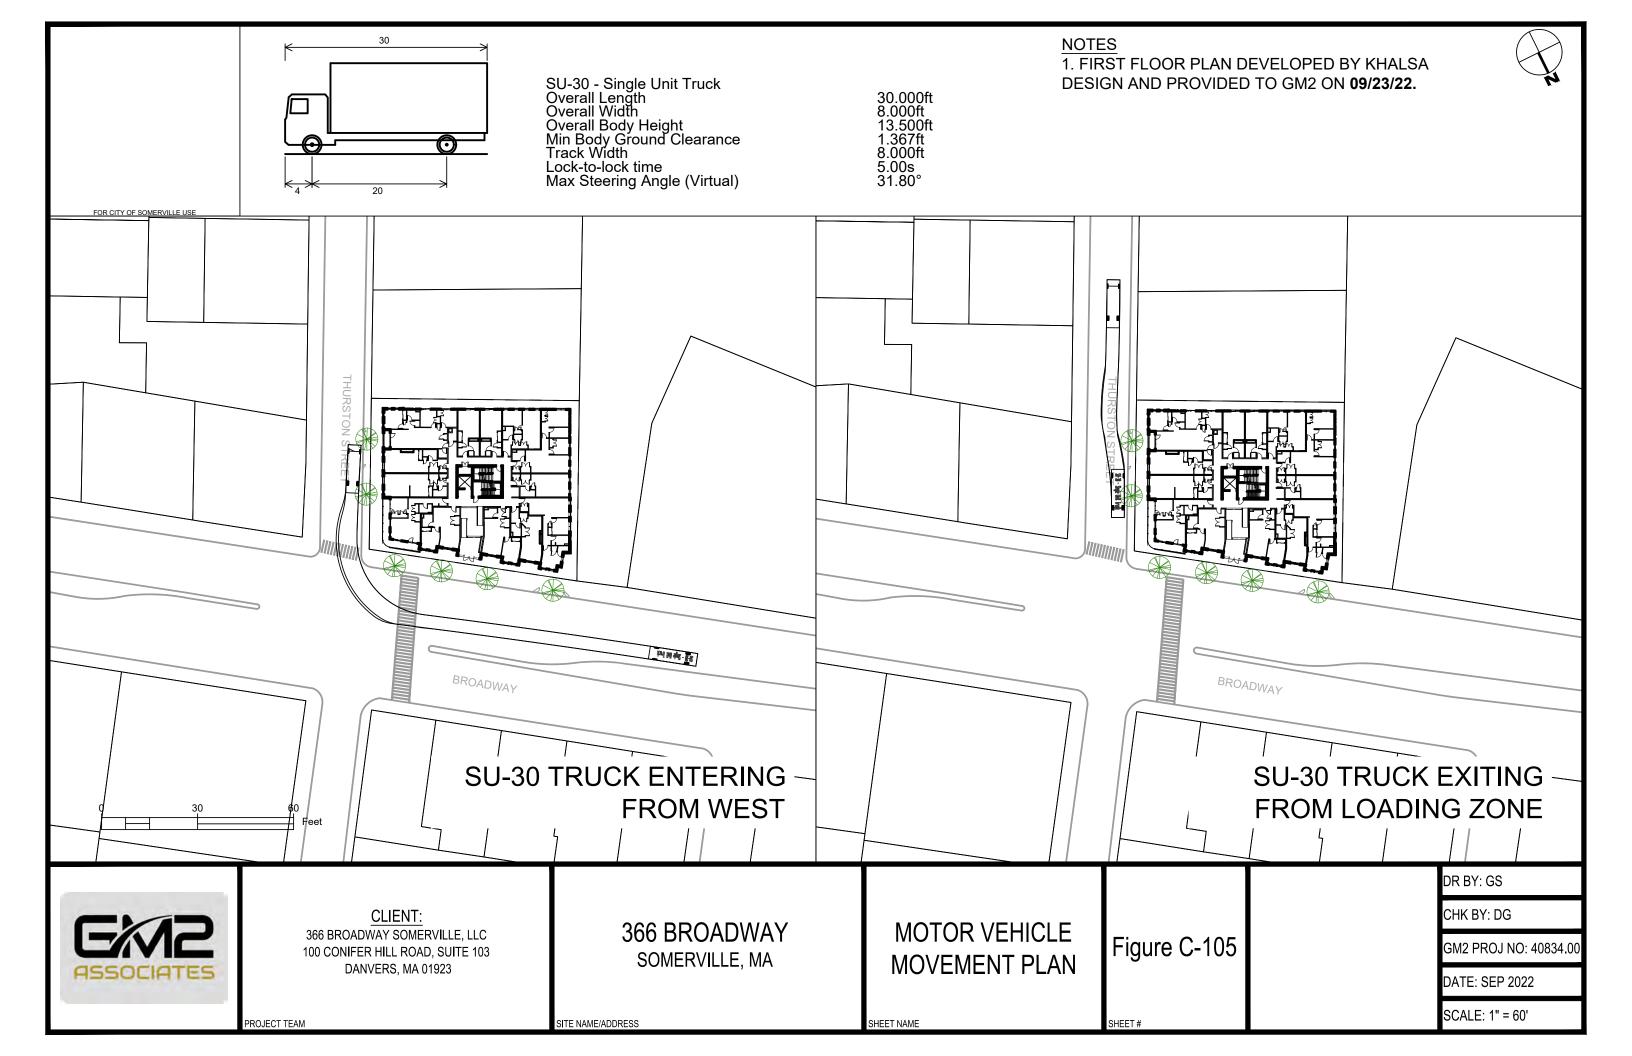




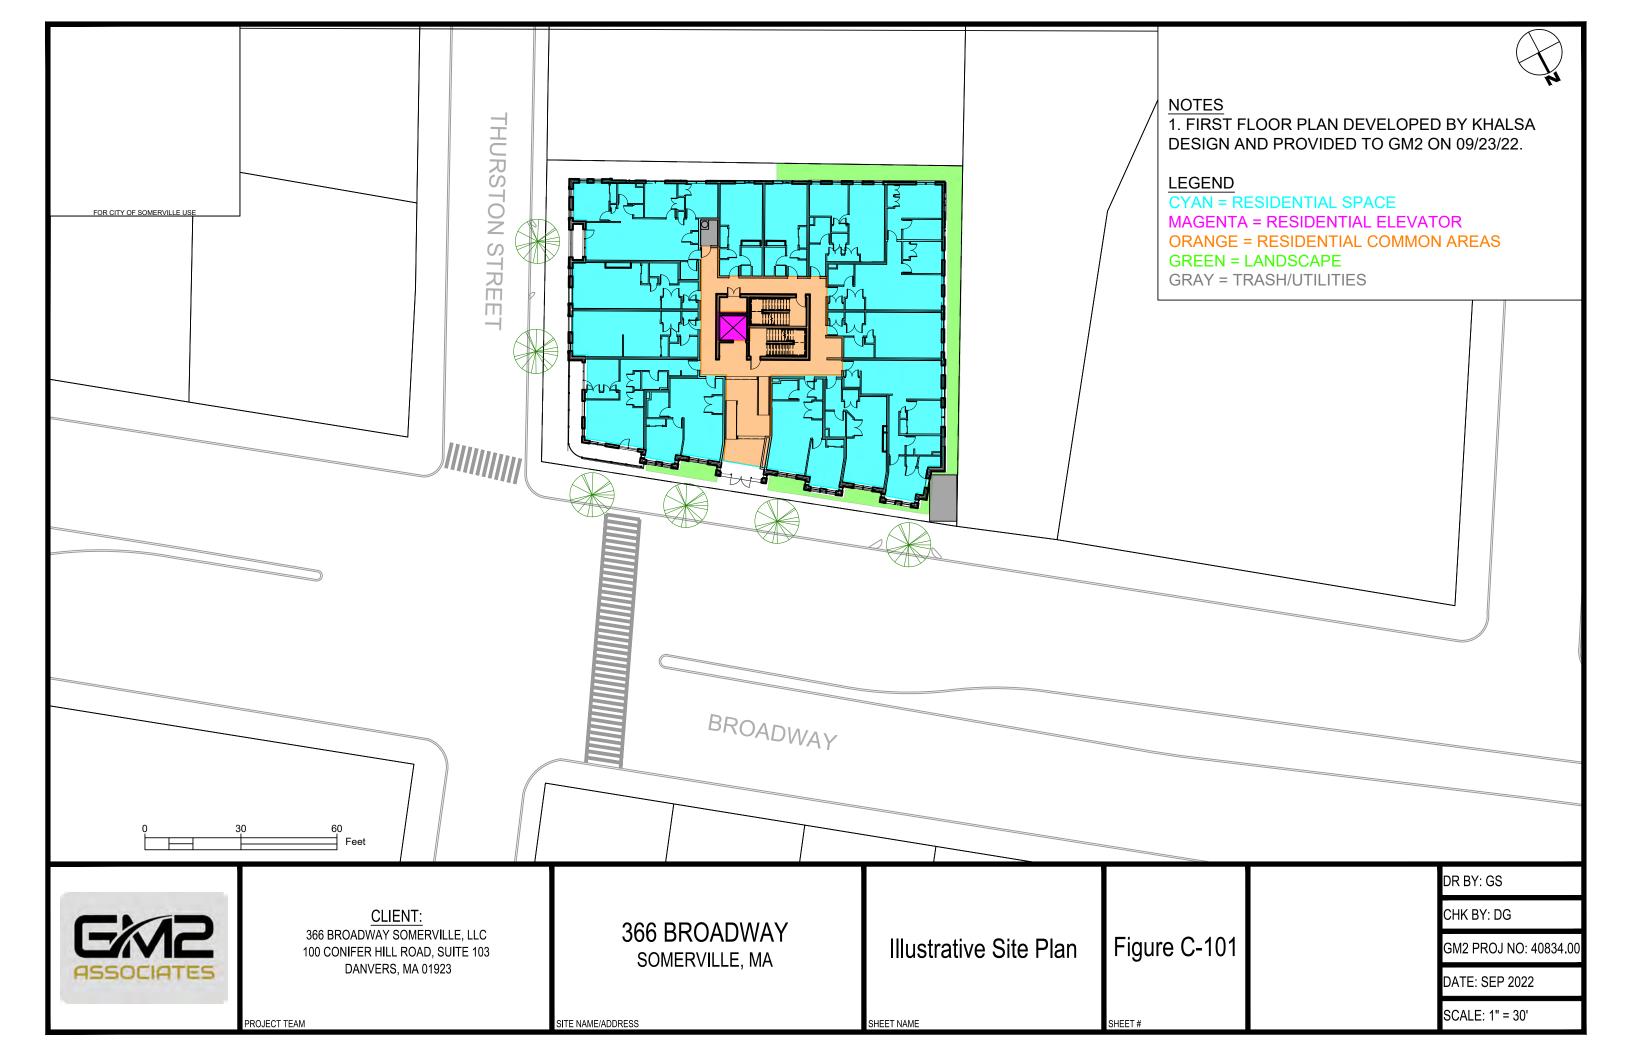

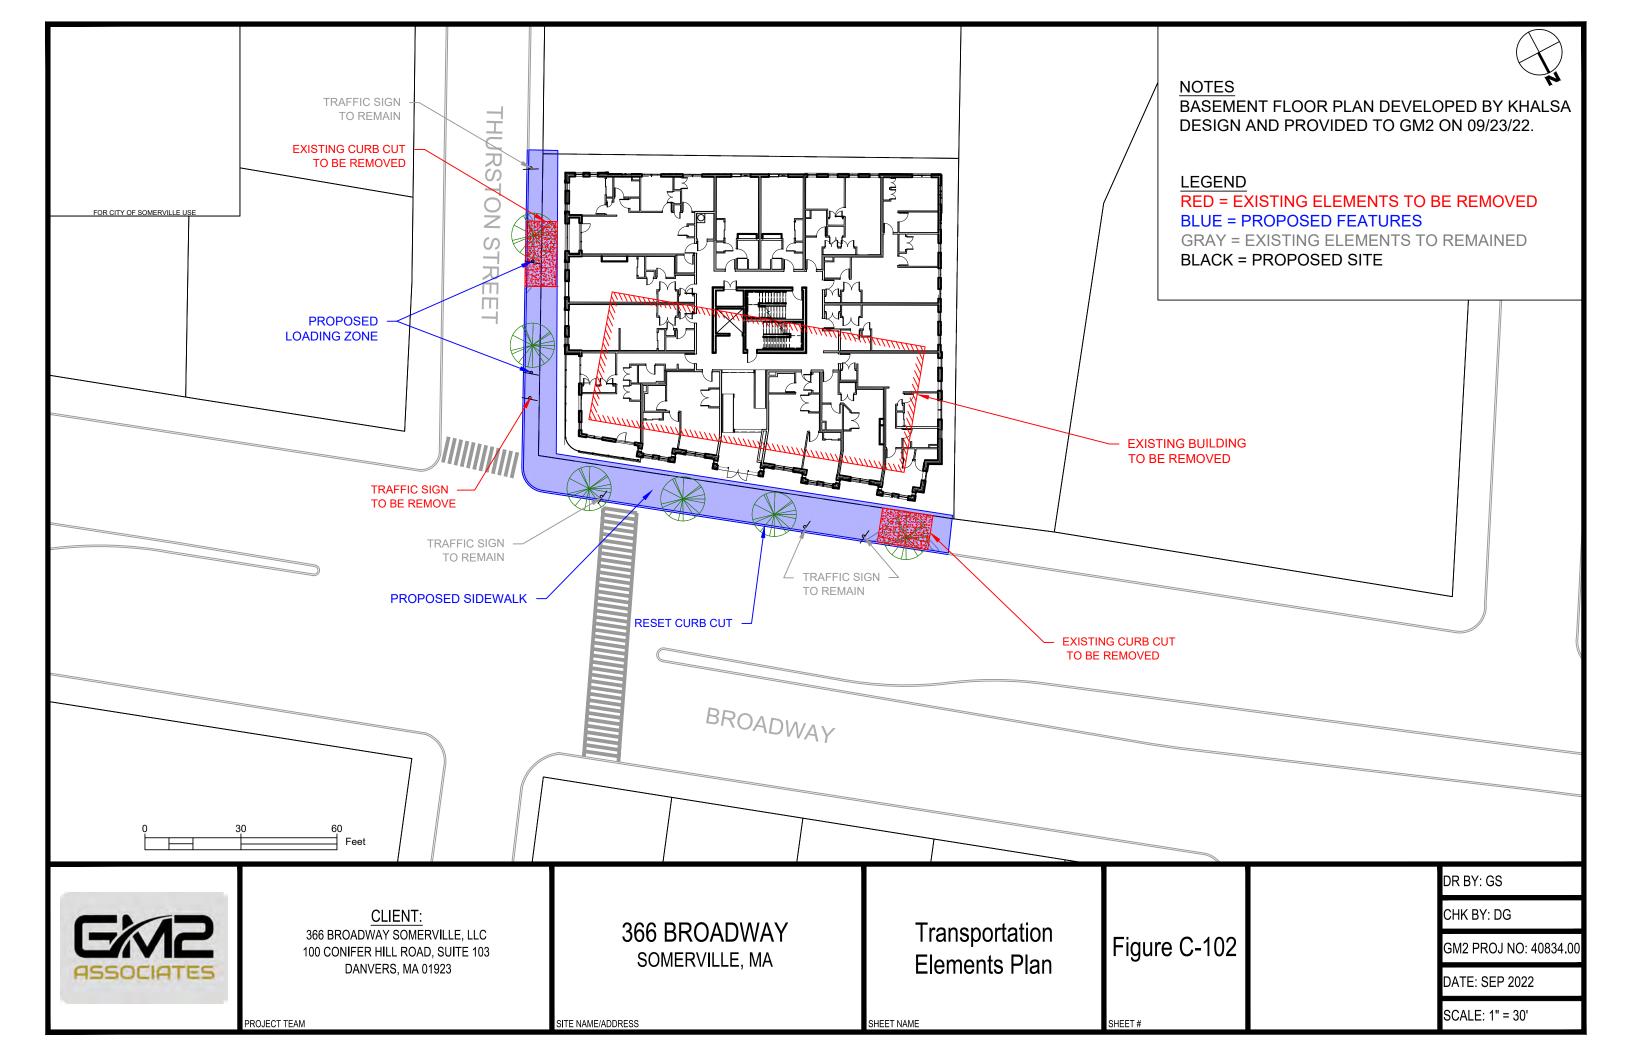

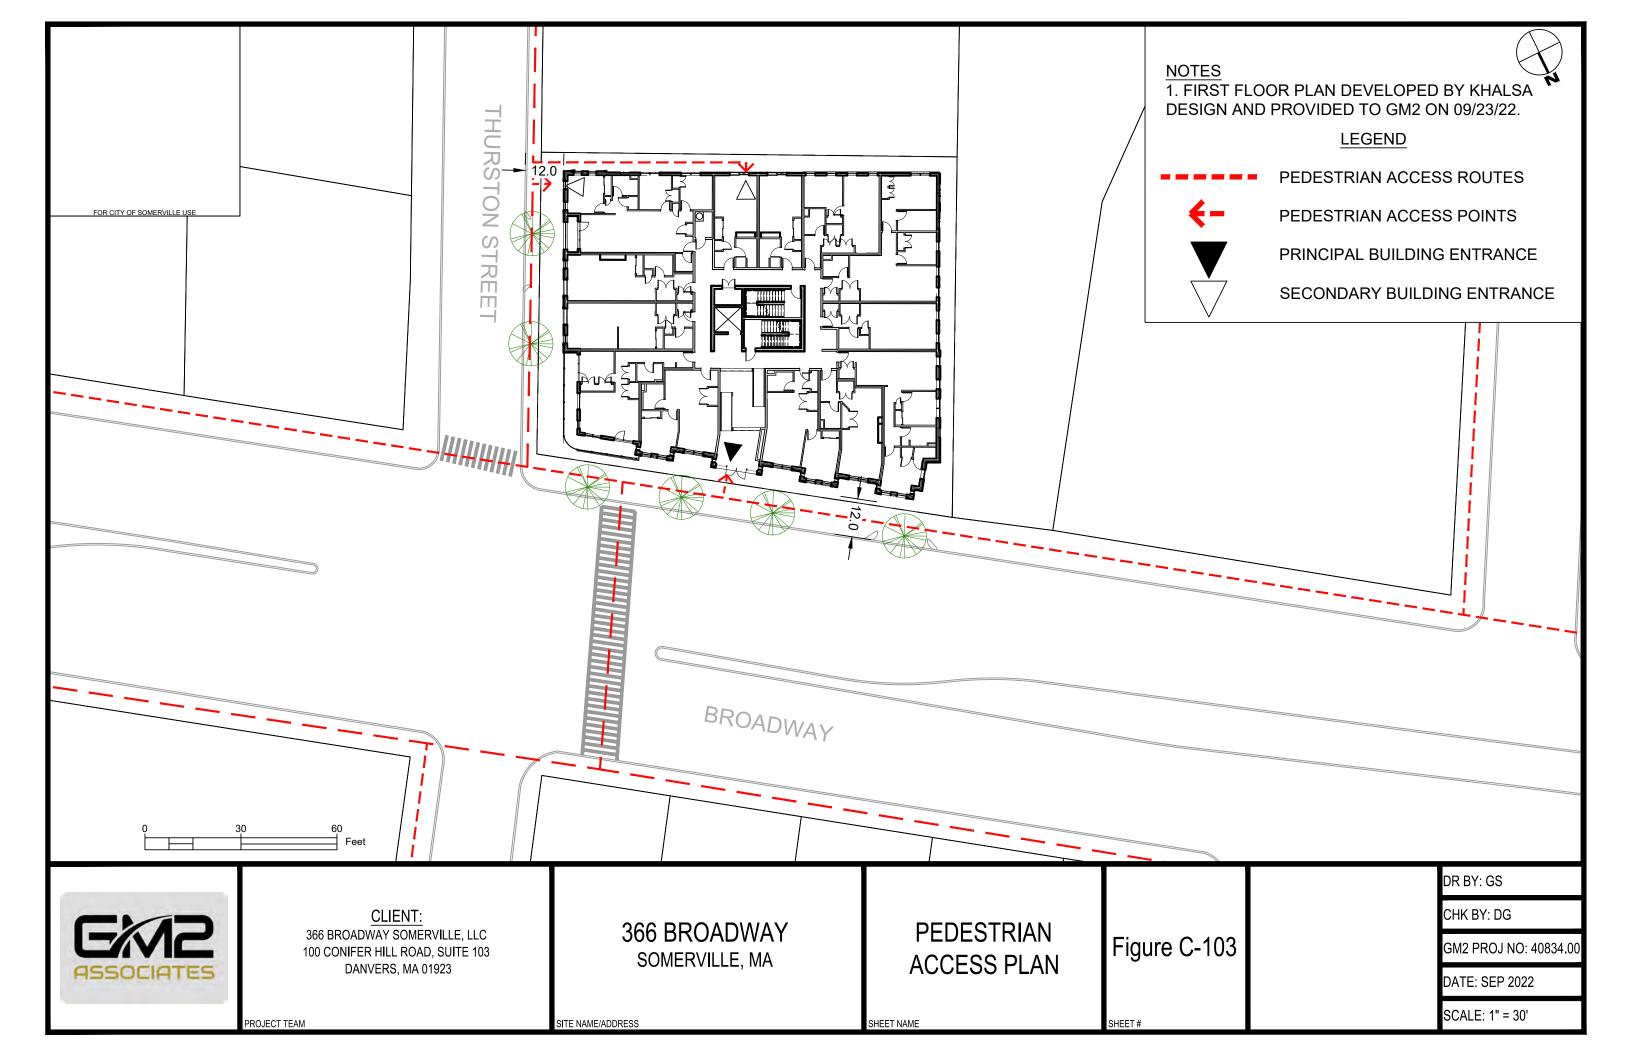

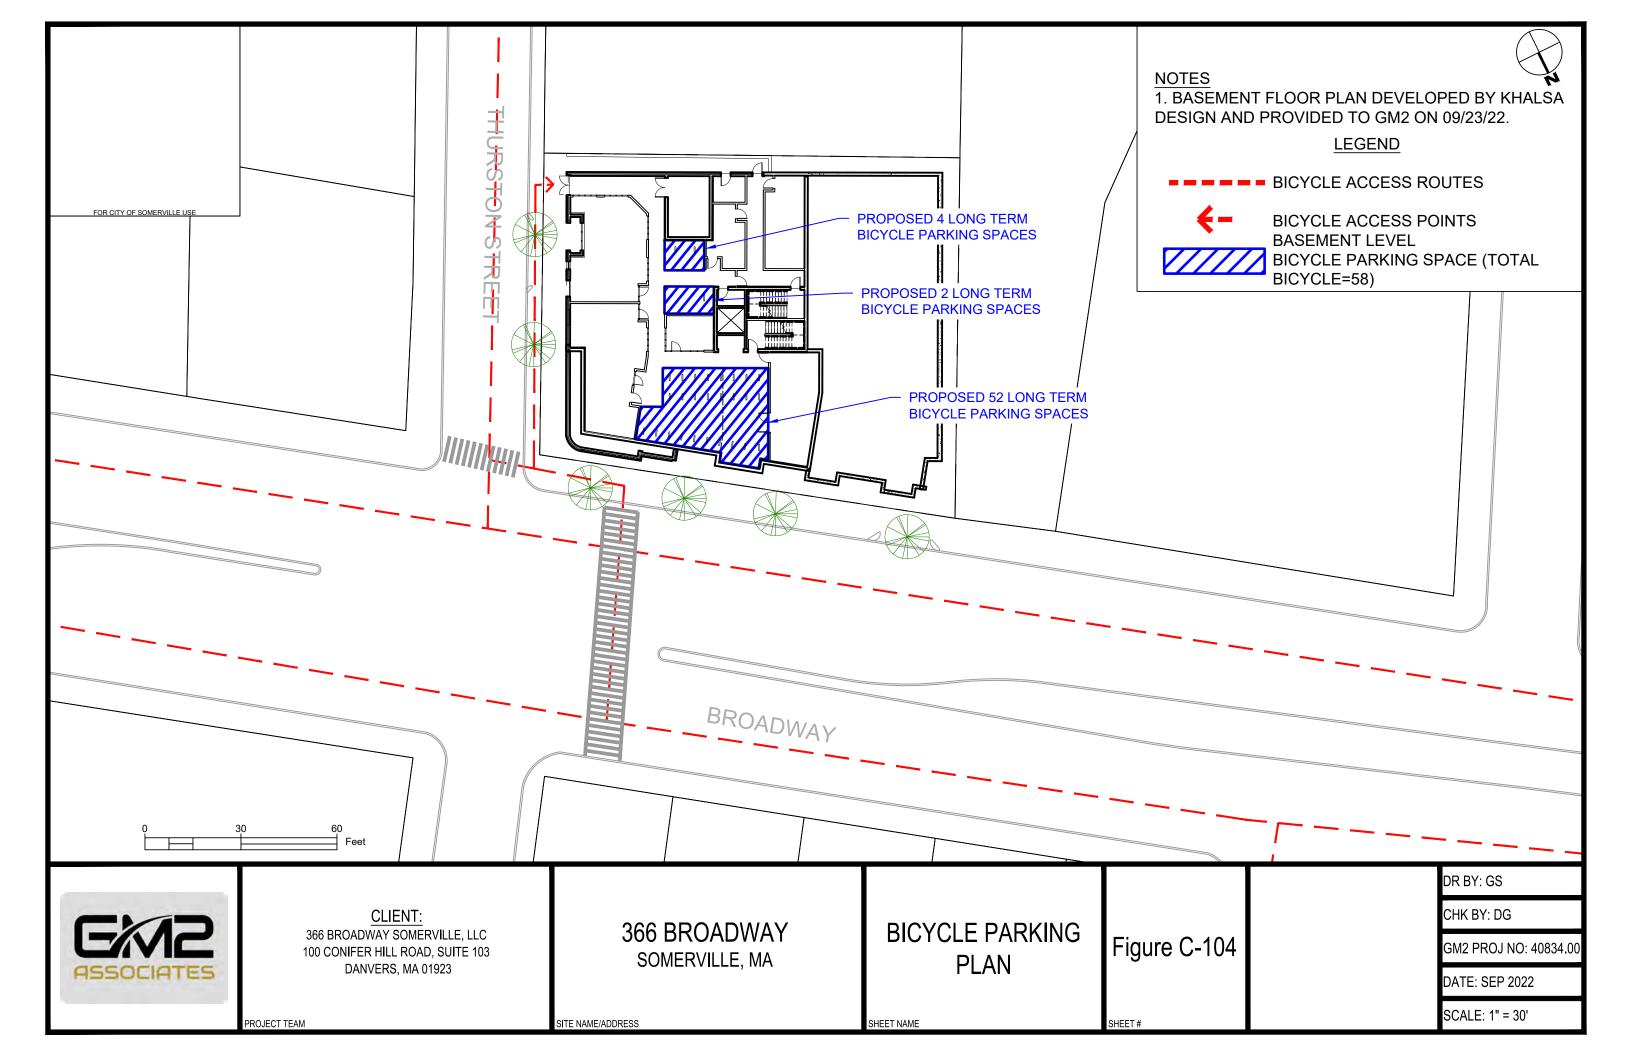

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Diagrammatic Section & Bldg

A-010


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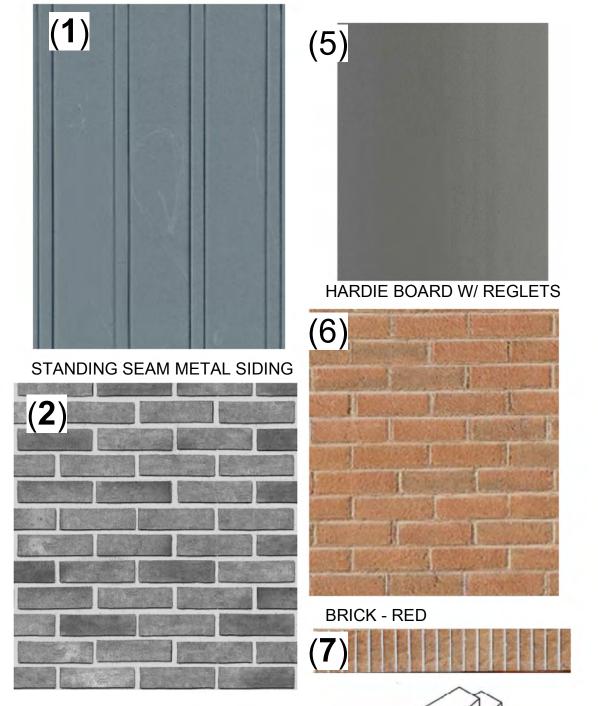
366 Broadway Residences

58 RESIDENTIAL UNITS LEED GOLD CERTIFIABLE PASSIVE HOUSE READY ±49,900 G.S.F.

4 STORIES OF TYPE 5A (2,3,4,R) OVER 1 STORY TYPE 1A CONSTRUCTION (1ST + BASEMENT)

1 ELEVATOR
CENTRAL CORE STAIR
LAYOUT:CORRIDOR WALLS REQUIRE
SAME FIRE RATING AS STAIR



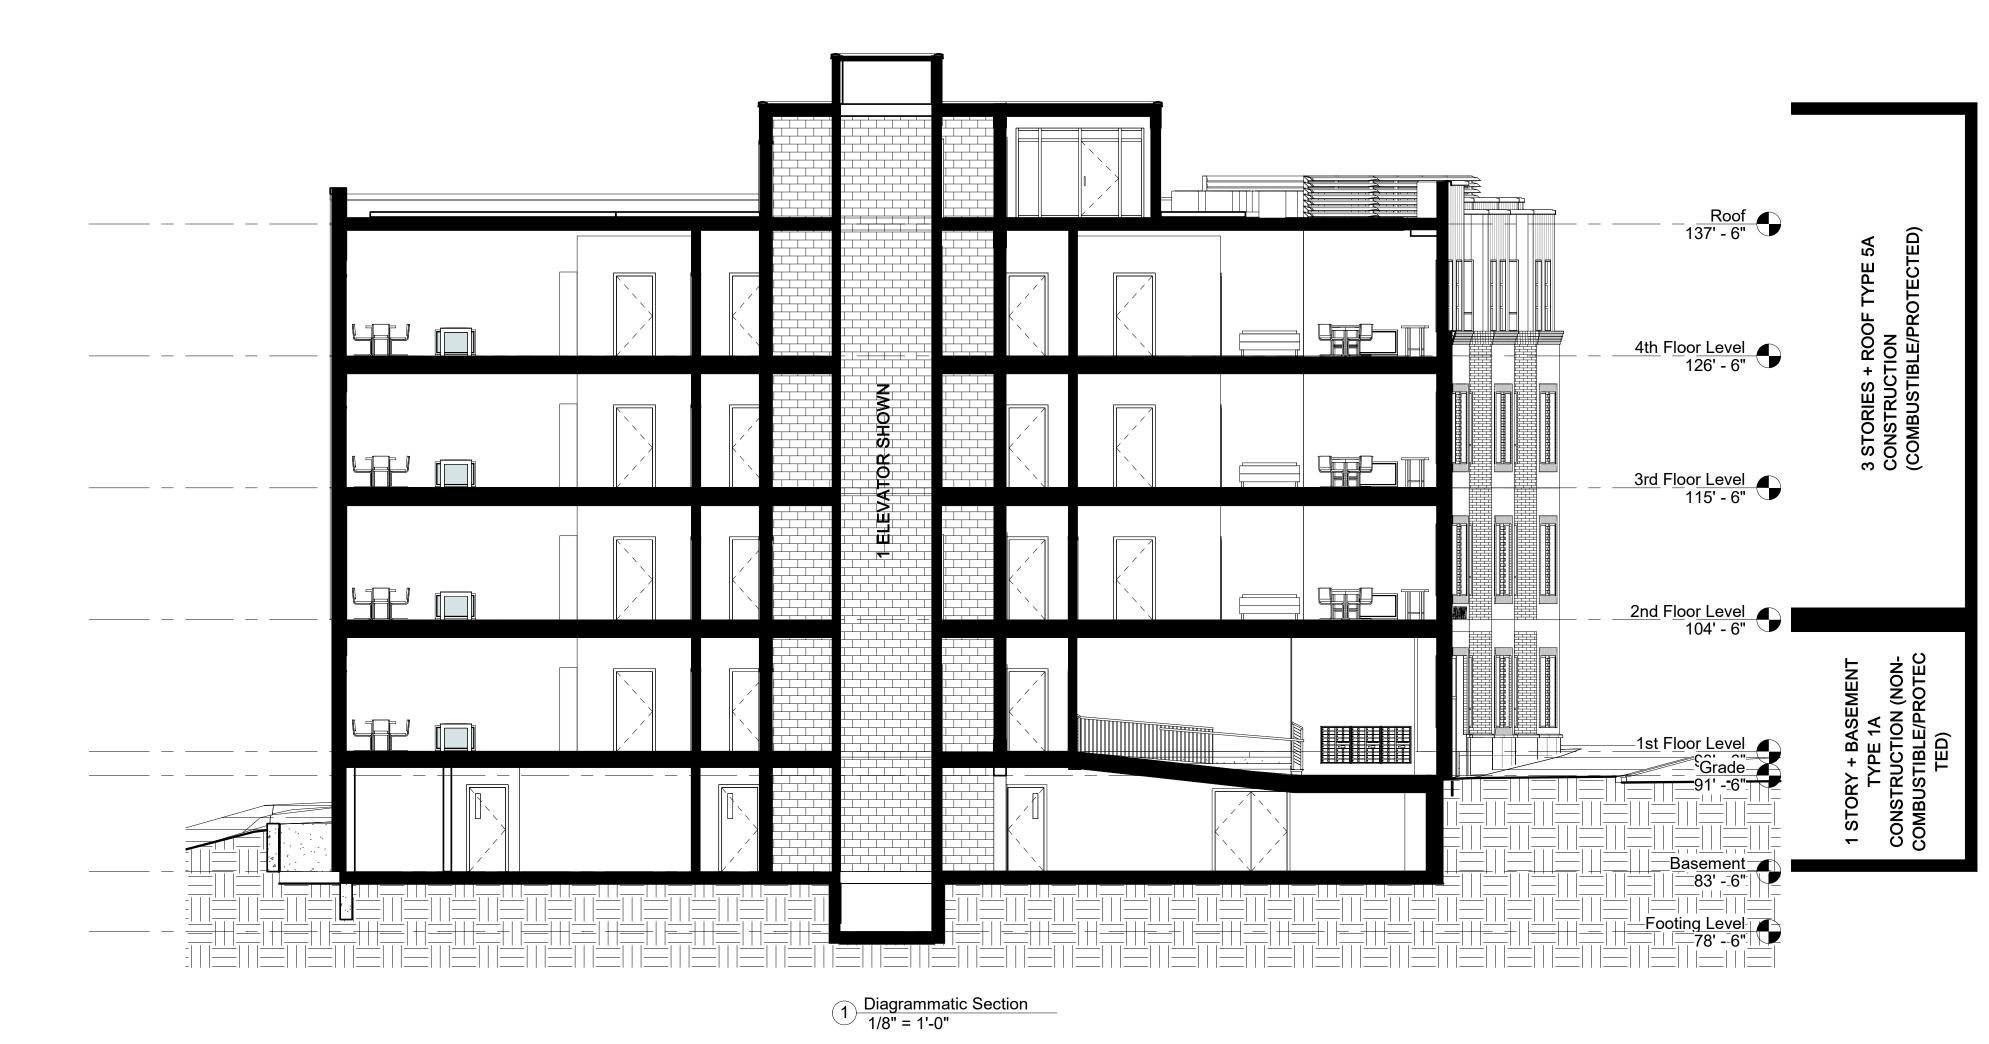


(3)

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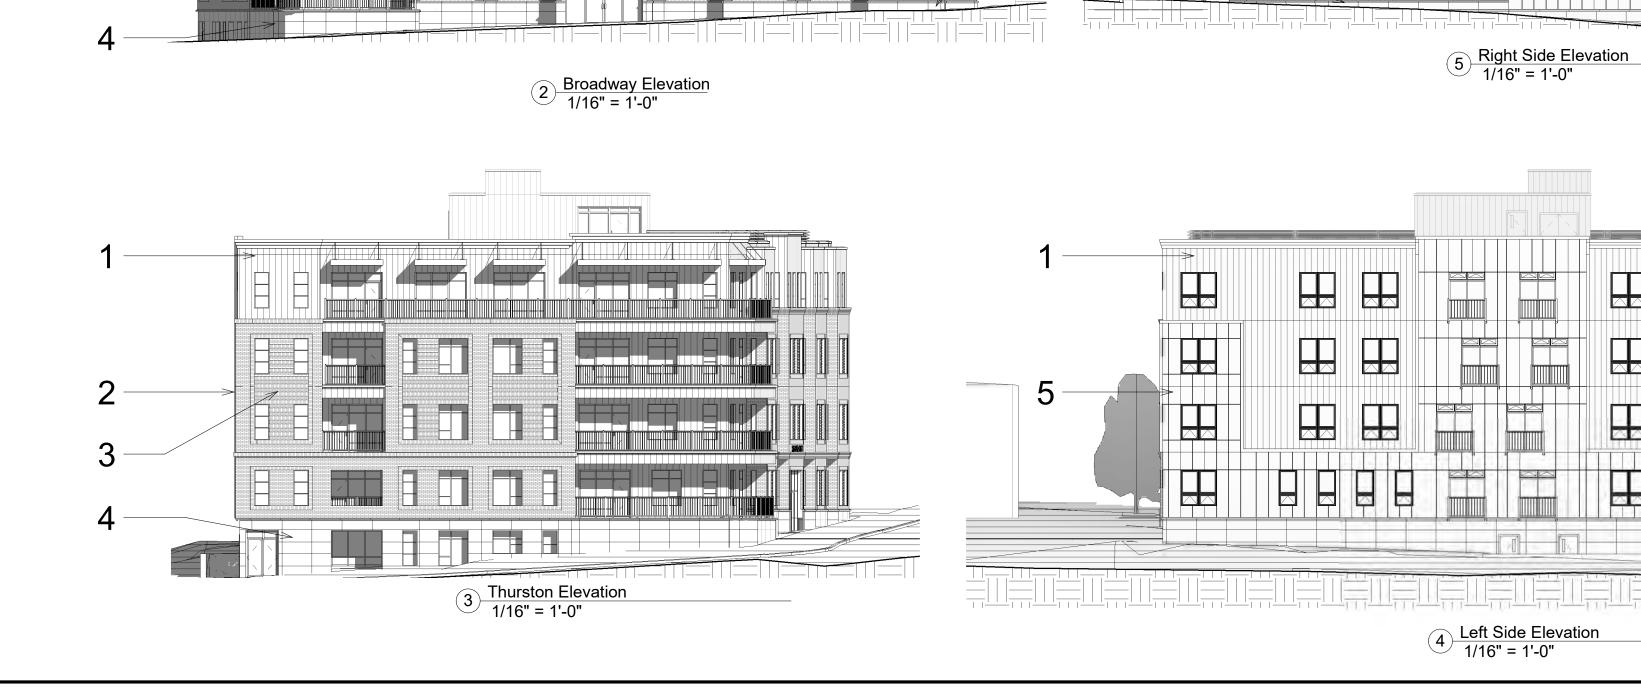
TABLE

PATTERNED BRICK - GREY

CAST STONE WATER



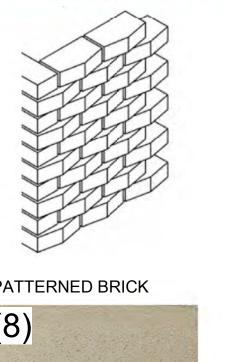



366 Broadway Residences

PROJECT ADDRESS

366 Broadway Somerville, MA


366 Broadway Somerville LLC



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Site Plan

A-020 366 Broadway Residences

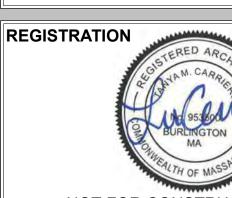

PROJECT ADDRESS

366 Broadway Somerville, MA

CLIENT

366 Broadway Somerville LLC

ARCHITECT




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REGISTRATION



	Tarris Gr		2101
Date		07	7/26/2023
Drawn b	у		ERS
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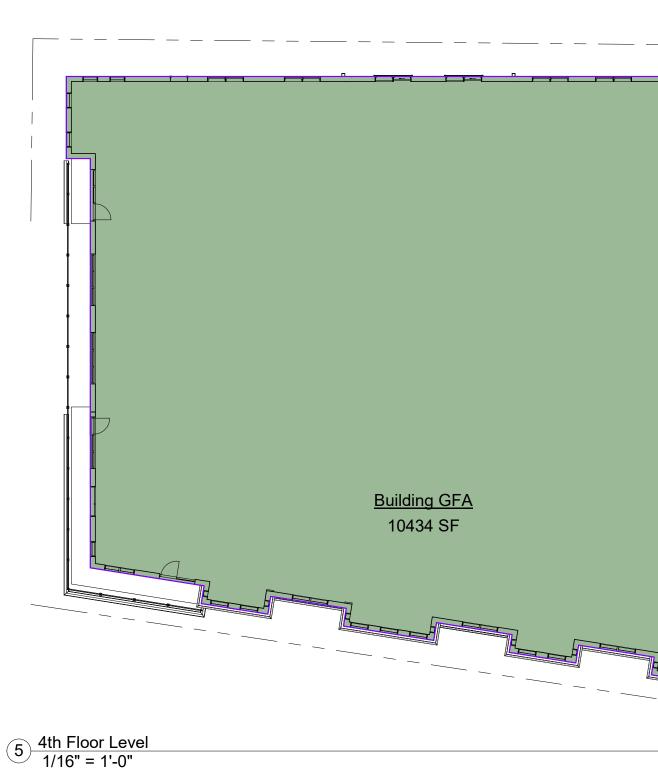
No.	Description	Date


Gross Floor Area

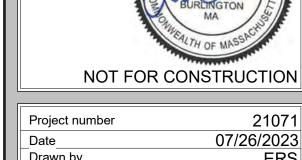A-023

366 Broadway Residences





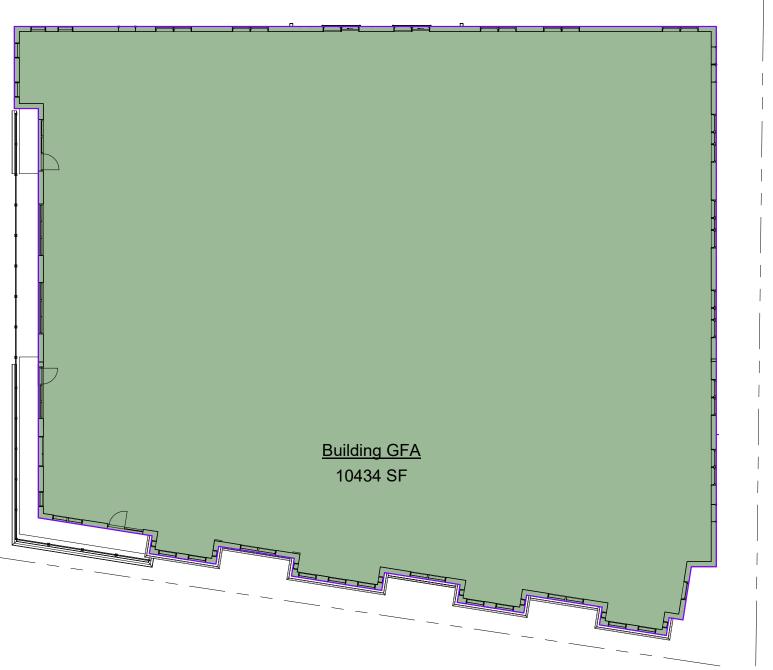

4 3rd Floor Level 1/16" = 1'-0"

Building GFA

10642 SF

Building GFA

Basement 1/16" = 1'-0"

6523 SF

Gross Building Area Area Level **Building GFA** 10676 SF 1st Floor Level 10646 SF 2nd Floor Level Building GFA Building GFA 10642 SF 3rd Floor Level **Building GFA** 10434 SF 4th Floor Level Building GFA 6523 SF Basement


6 Roof 1/16" = 1'-0"

Building GFA

980 SF Roof 49900 SF 49900 SF

Building GFA 980 SF

BUILDING DENSITY: 49,900 NET ZERO READY (/850 S.F. PER DU) = 58 UNITS

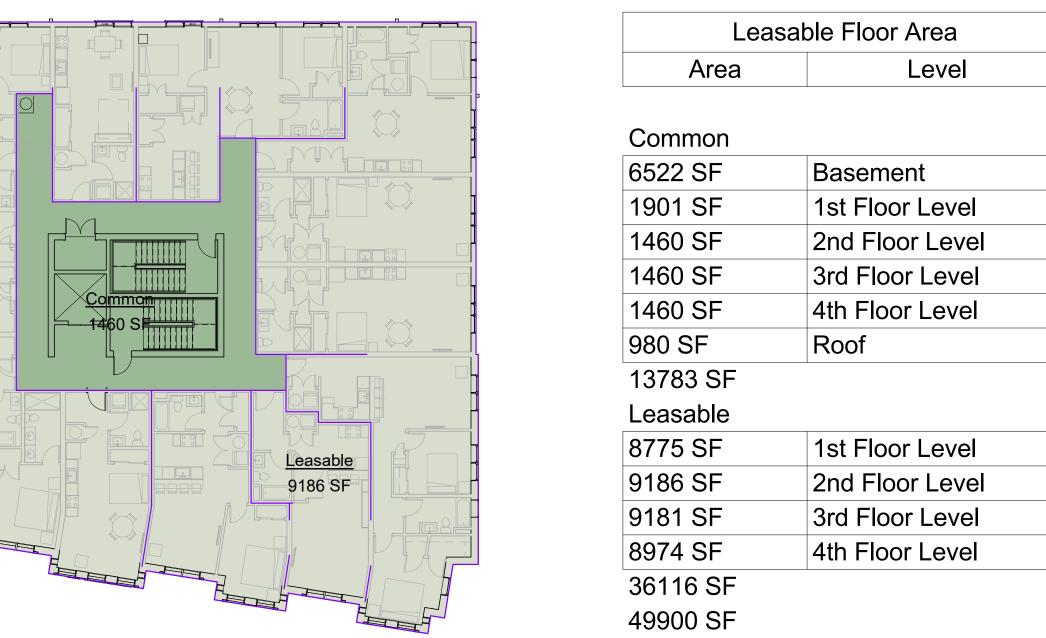



PROJECT ADDRESS 366 Broadway Somerville, MA CLIENT 366 Broadway Somerville LLC ARCHITECT KHALSA

PROJECT NAME

366 Broadway

Residences

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Project number		21071
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ру	JSK 1/16" = 1'-0"	
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Description		Date
	oy ONS	07 by 1/10 ONS

Leasable Floor Area

A-024





366 Broadway Residences

PROJECT ADDRESS

366 Broadway Somerville, MA

CLIENT

366 Broadway Somerville LLC

ARCHITECT




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No.	Description	

Basement Floor Plan

A-100

366 Broadway Residences

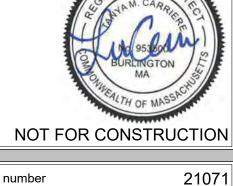
366 Broadway Somerville, MA

366 Broadway Somerville LLC



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Description	Date	

366 Broadway Residences

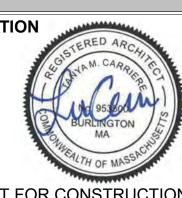PROJECT ADDRESS 366 Broadway Somerville, MA

CLIENT

366 Broadway Somerville LLC

ARCHITECT




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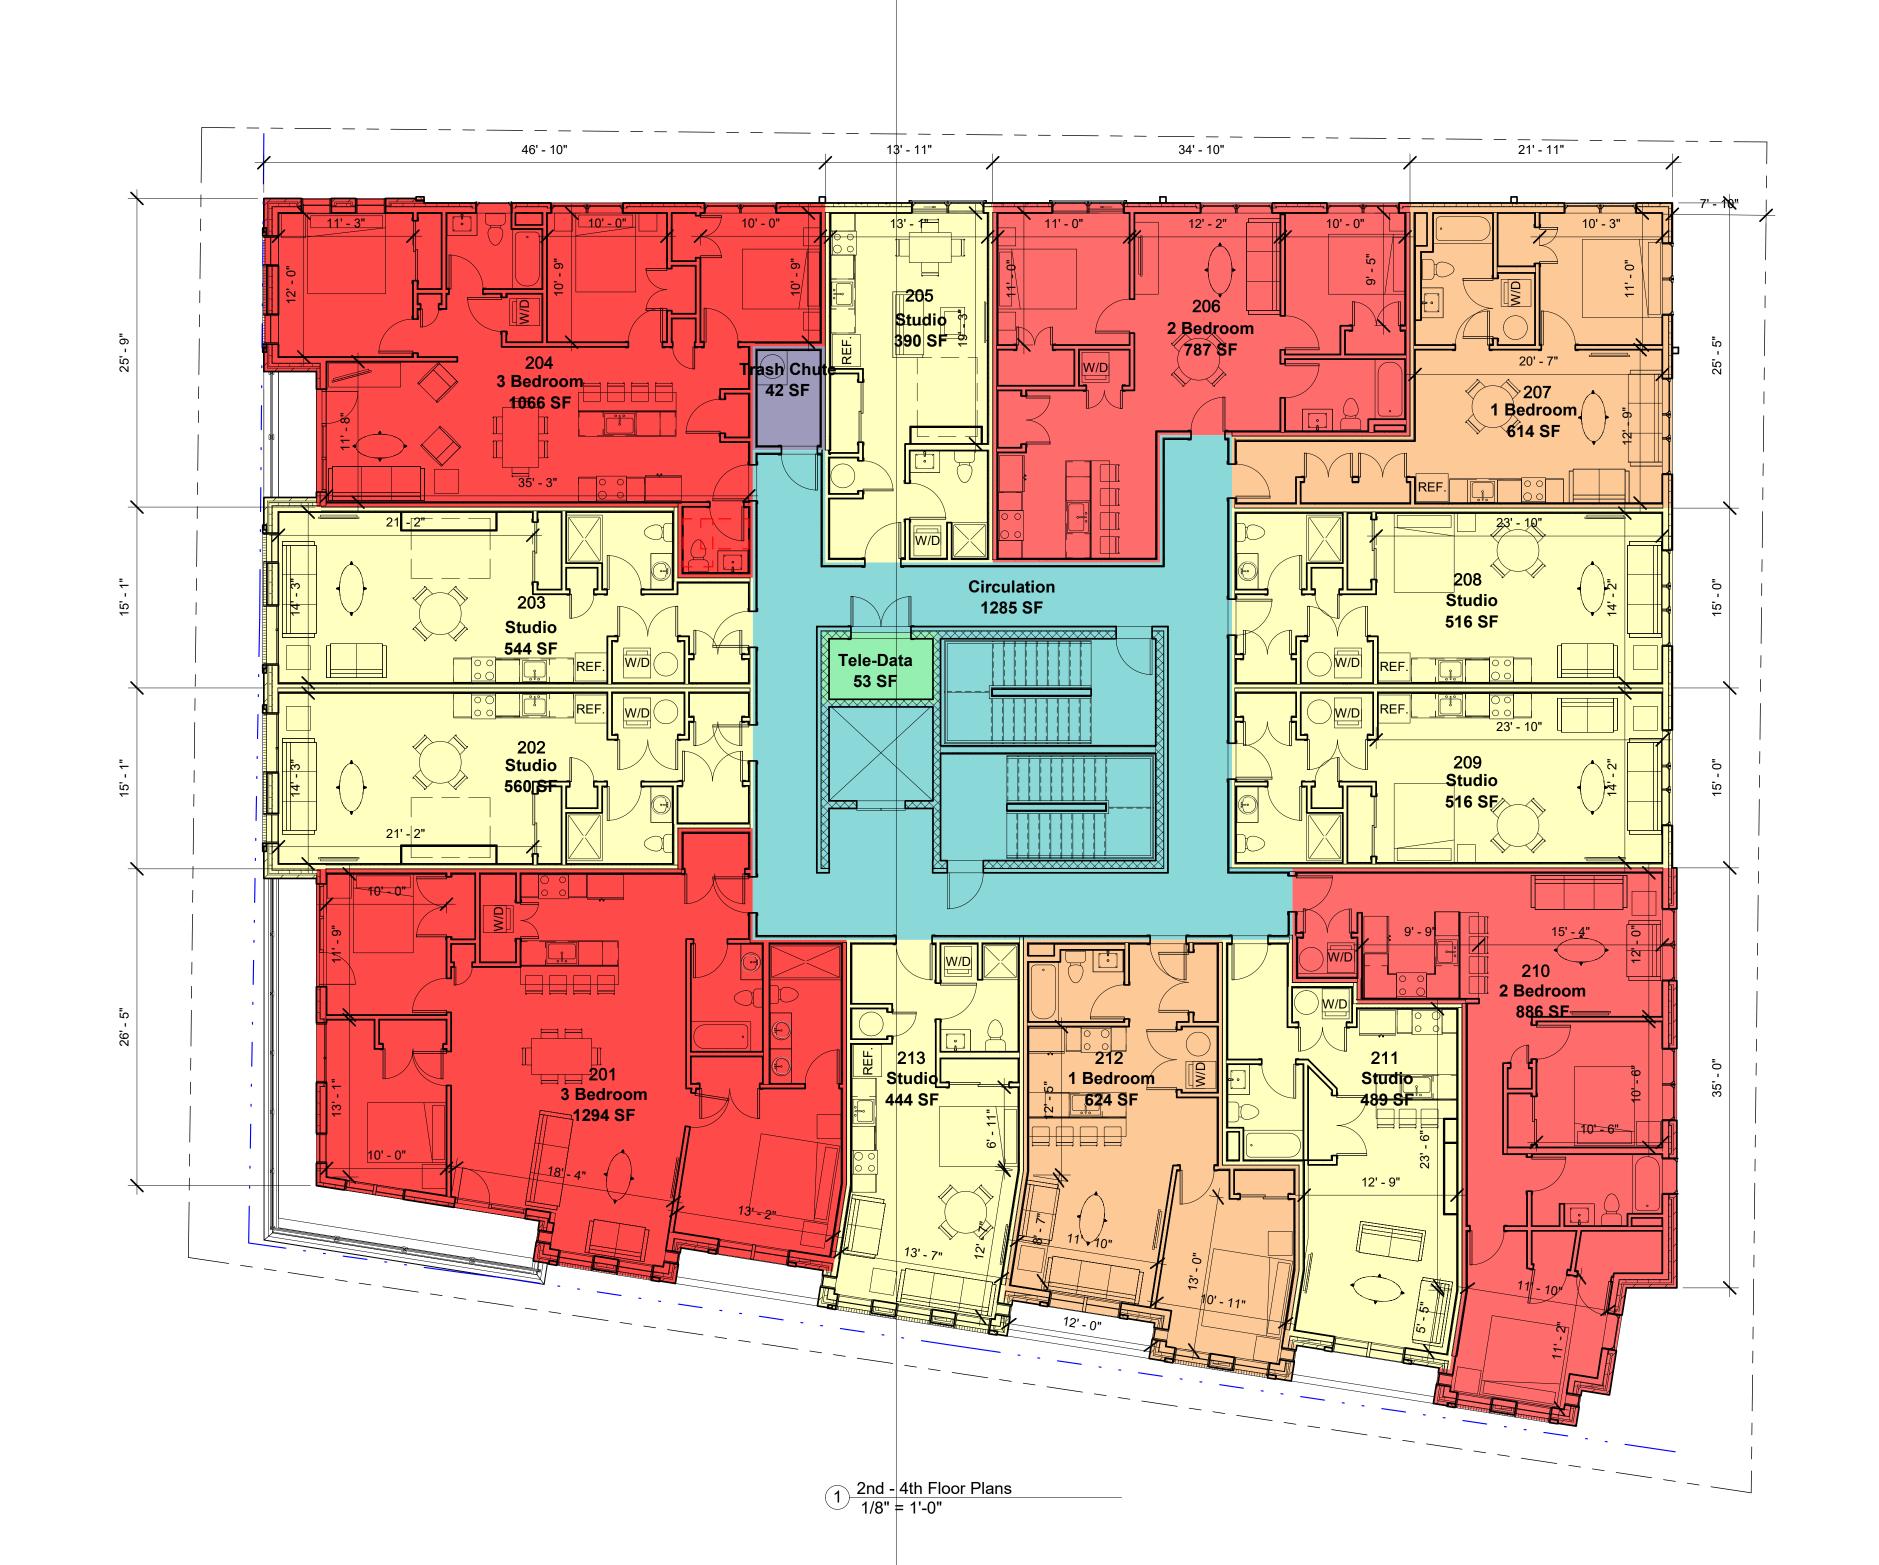
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Date	07/26/202
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2nd - 4th Floor Plans



	UNIT BREAKDOWN BY FLOOR					
FLOOR	STUDIO	1 BEDROOM	2 BEDROOM	3 BEDROOM	TOTAL	COMMENTS
1	5	1	4	1	11	
2	7	2	2	2	13	
3	7	2	2	2	13	
4	7	2	2	2	13	
TOTAL	26 (52%)	7 (14%)	10 (20%)	7 (14%)	50	

26/2023 1:28:03 PM

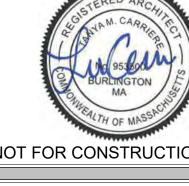PROJECT NAME

366 Broadway Residences

PROJECT ADDRESS

366 Broadway Somerville, MA

CLIENT

366 Broadway Somerville LLC

ARCHITECT



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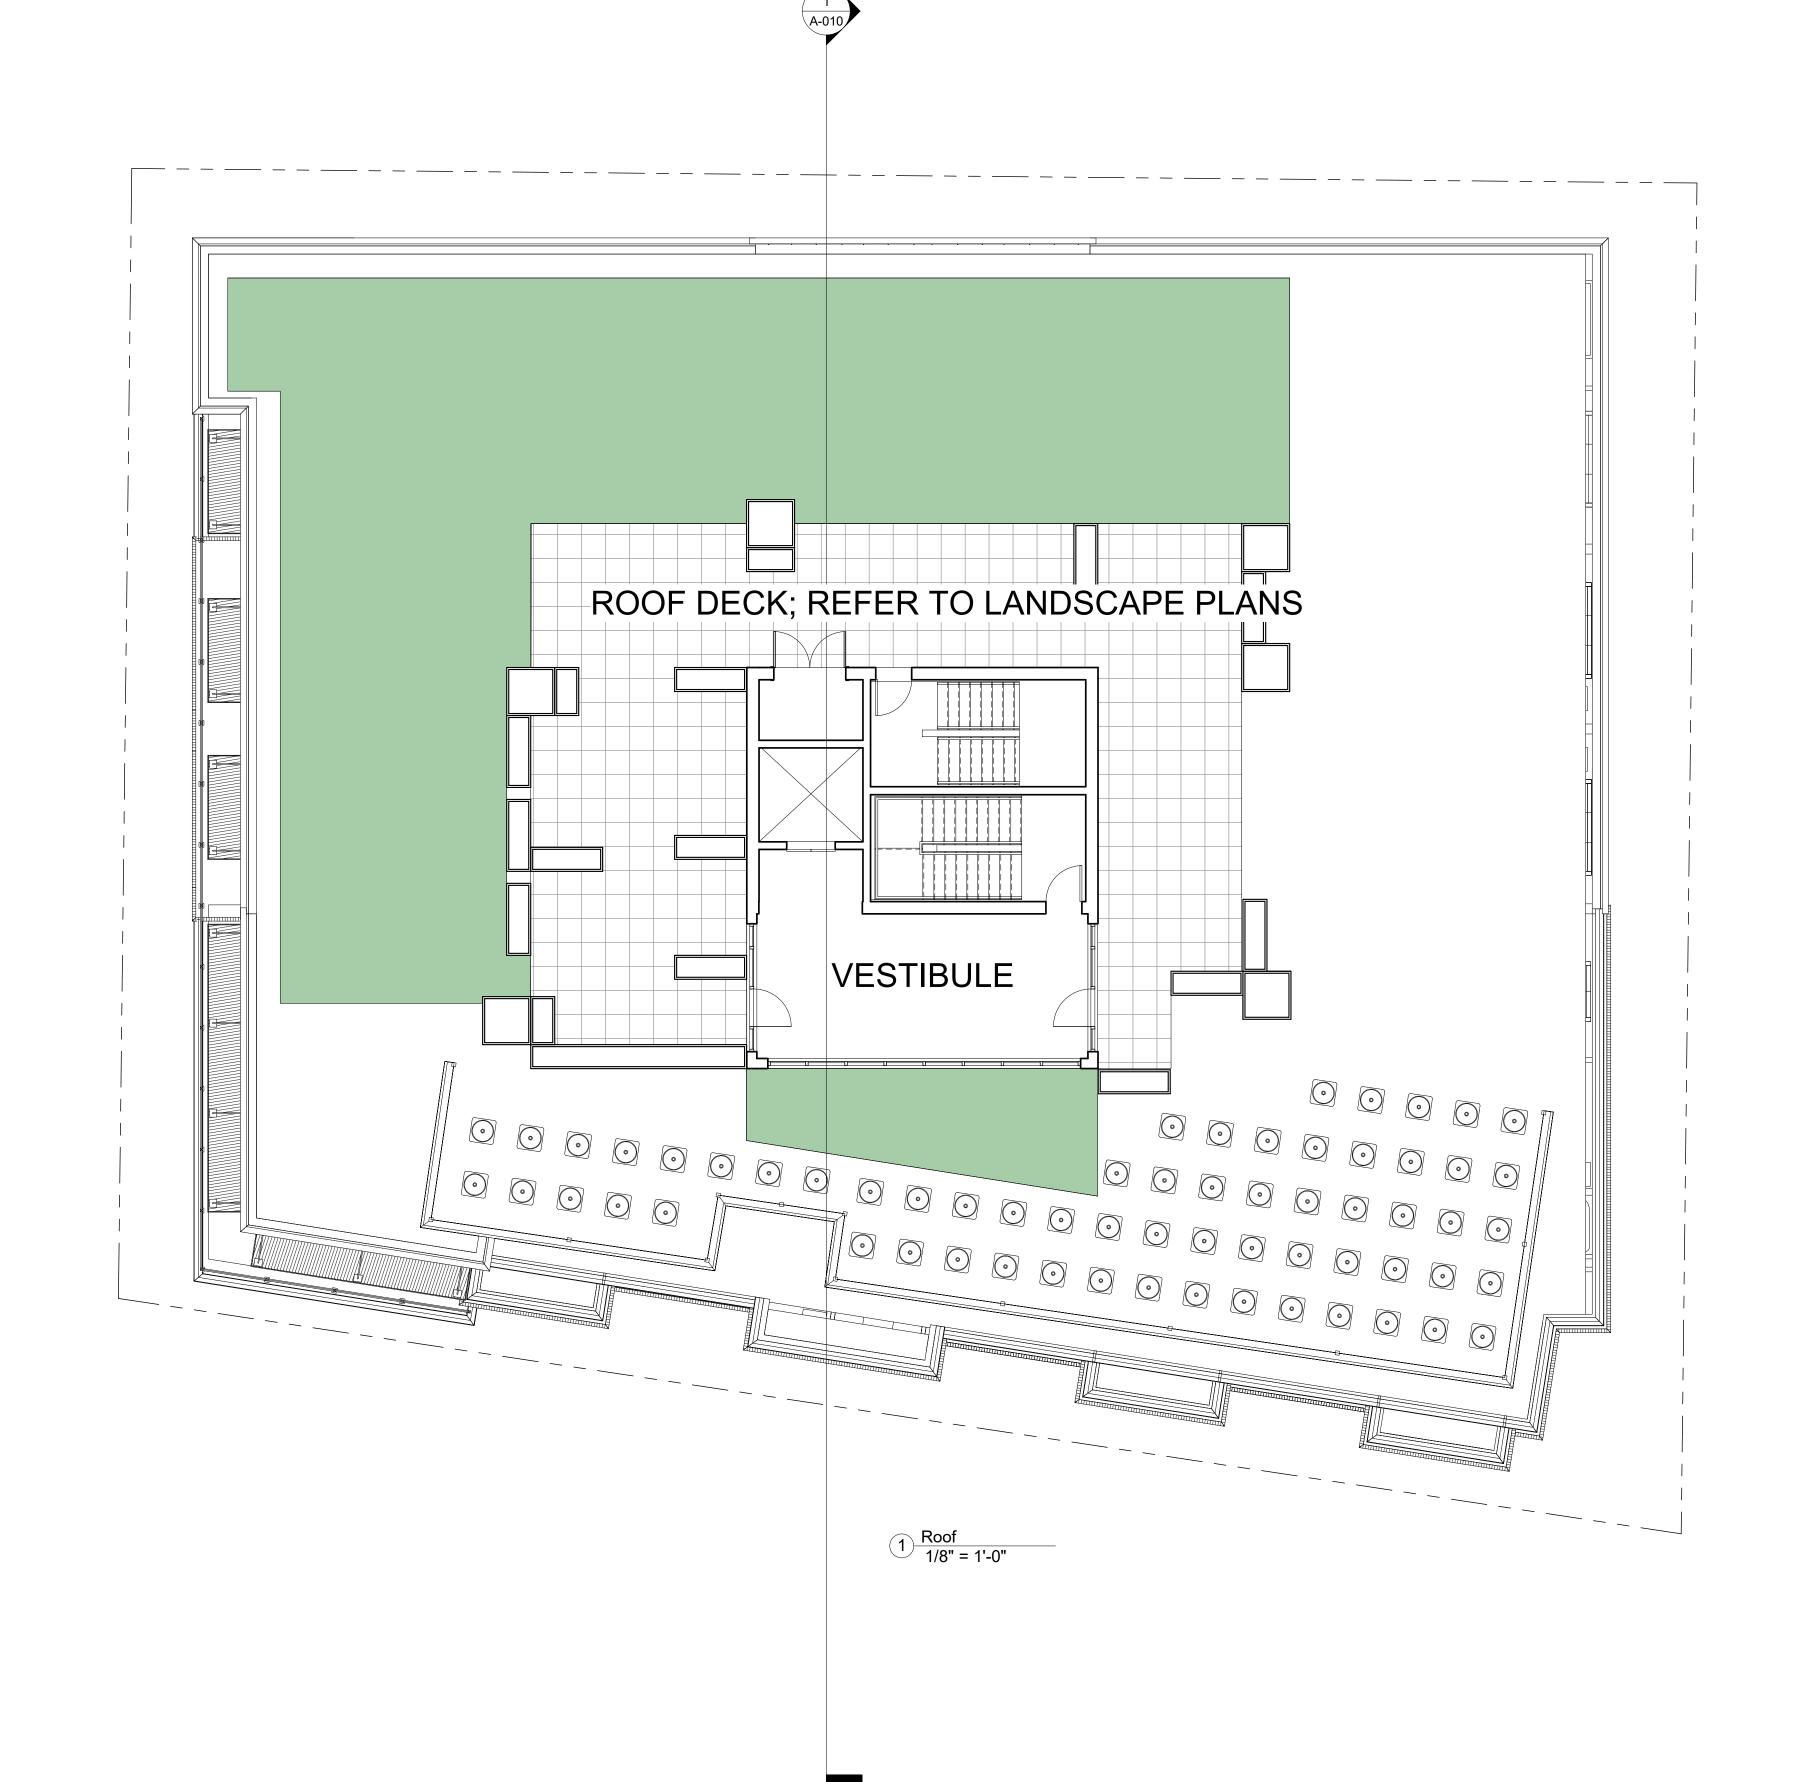
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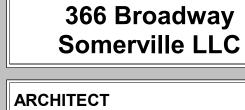
Roof Plan

A-103

366 Broadway Residences



		UNIT	BREAKDOWN B	Y FLOOR		
FLOOR	STUDIO	1 BEDROOM	2 BEDROOM	3 BEDROOM	TOTAL	COMMENTS
1	5	1	4	1	11	
2	7	2	2	2	13	
3	7	2	2	2	13	
4	7	2	2	2	13	
TOTAL	26 (52%)	7 (14%)	10 (20%)	7 (14%)	50	



366 Broadway

Residences

PROJECT NAME


PROJECT ADDRESS


CLIENT




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CONSULTANTS:



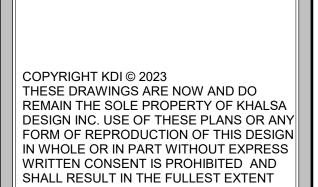

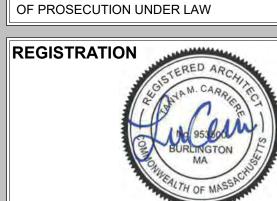
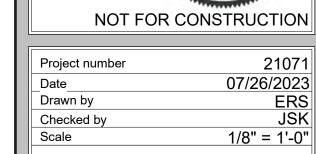
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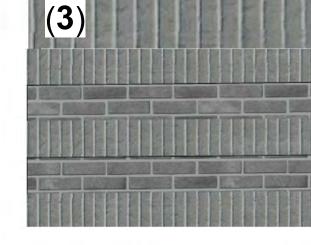
Primary Front Elevation -Broadway

366 Broadway Residences









BRICK - GREY


PATTERNED BRICK - GREY



CAST STONE WATER TABLE



Primary Front (Broadway) Elevation 1/8" = 1'-0"

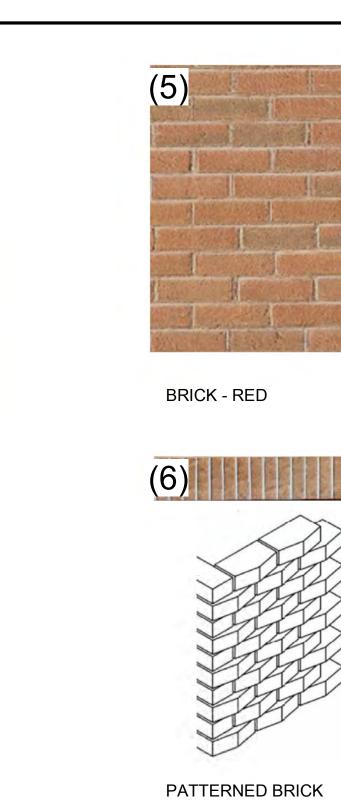


(7)

TABLE


CAST STONE WATER



STANDING SEAM METAL SIDING

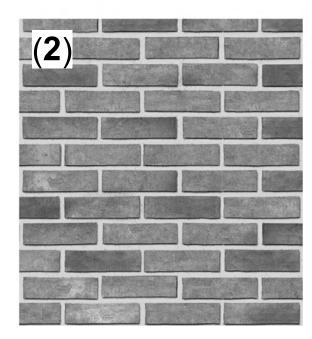

BRICK - GREY

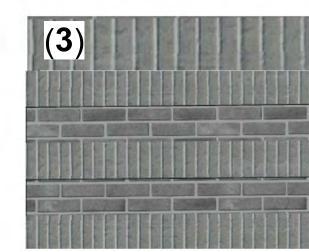

PATTERNED BRICK - GREY




CAST STONE WATER TABLE






Secondary Front Elevation (Thurston)
1/8" = 1'-0"

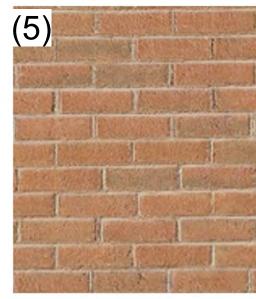



BRICK - RED

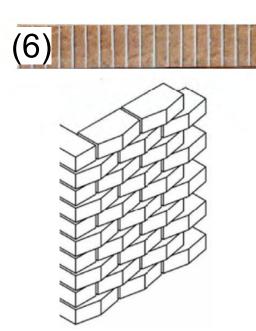

PATTERNED BRICK

TABLE

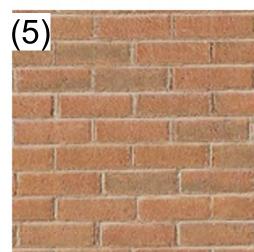

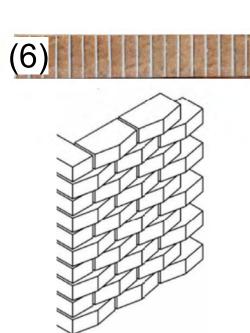



CAST STONE WATER

PROJECT NAME

366 Broadway Residences

PROJECT ADDRESS

366 Broadway Somerville, MA

CLIENT


366 Broadway Somerville LLC





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CONSULTANTS:



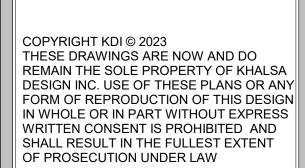



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Project number	21071		
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Scale	1/8" = 1'-0"		
REVISIONS			

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No.	Description	Date	

Secondary Front Elevation-Thurston

A-302

366 Broadway Residences

PROJECT ADDRESS

366 Broadway Somerville, MA

CLIENT

366 Broadway Somerville LLC

ARCHITECT



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No.	Description	Date

Side Elevations

A-303

366 Broadway

Residences

PROJECT NAME

PROJECT ADDRESS 366 Broadway Somerville, MA

CLIENT

366 Broadway Somerville LLC

ARCHITECT



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Perspective at Broadway & Thurston

AV-1 366 Broadway Residences



366 Broadway
Residences
PROJECT ADDRESS
366 Broadway
Somerville, MA

PROJECT NAME

CLIENT

366 Broadway Somerville LLC

ARCHITECT




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Project number	210
Date	07/26/20
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Perspective at Broadway

AV-2
366 Broadway Residences



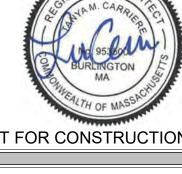

NOT FOR CONSTRUCTION 21071 07/26/2023 Author Checker Project number

Checked by

Drawn by

PROJECT NAME

PROJECT ADDRESS

CLIENT

ARCHITECT

366 Broadway

Residences

366 Broadway Somerville, MA

366 Broadway Somerville LLC

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CONSULTANTS:

REVISIONS

Date Description

> Thurston Street Perspective

AV-3 366 Broadway Residences



366 Broadway Residences

PROJECT ADDRESS

366 Broadway Somerville, MA

CLIENT

366 Broadway Somerville LLC

ARCHITECT



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REGISTRATION

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Proposed Rendering

AV-4
366 Broadway Residences



366 Broadway Residences

PROJECT ADDRESS

366 Broadway Somerville, MA

CLIENT

366 Broadway Somerville LLC

ARCHITECT



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Proposed Rendering



366 Broadway Residences

PROJECT ADDRESS

366 Broadway Somerville, MA

CLIENT

366 Broadway Somerville LLC

ARCHITECT



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Proposed Aerial

366 Broadway Residences

PROJECT ADDRESS

366 Broadway Somerville, MA

CLIENT

366 Broadway Somerville LLC

ARCHITECT



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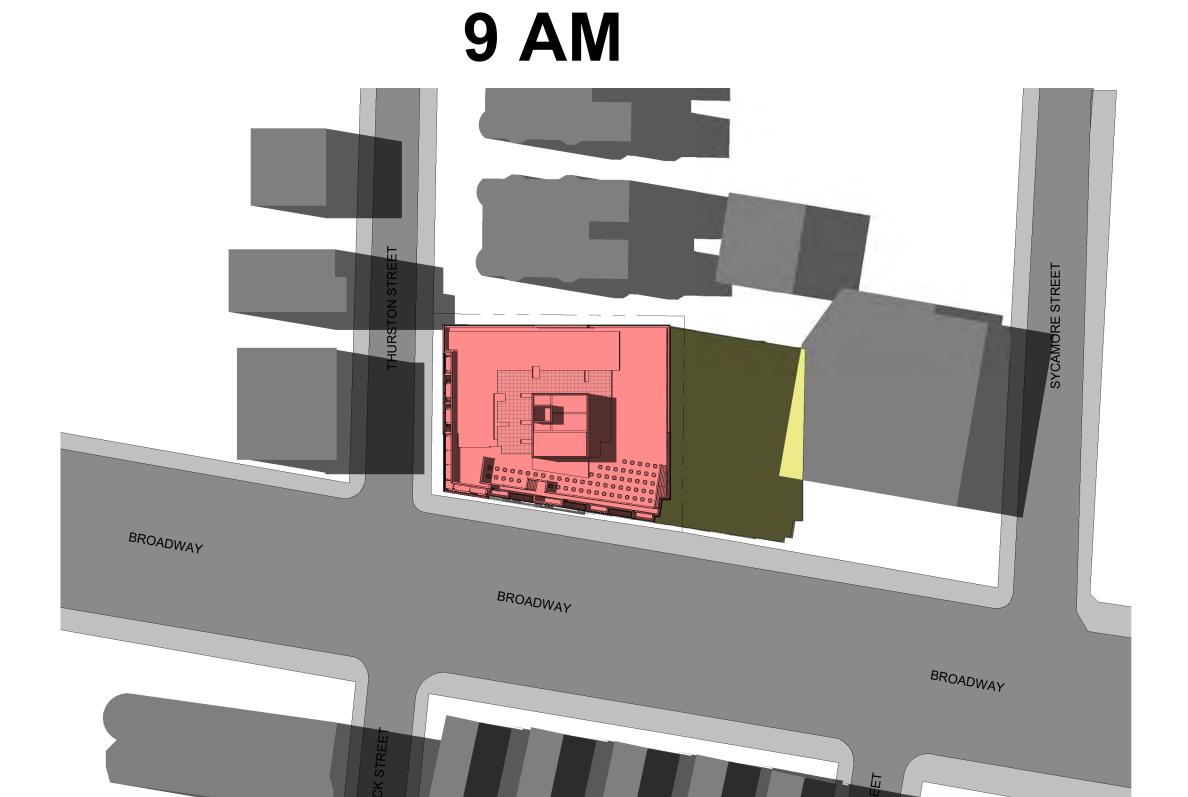
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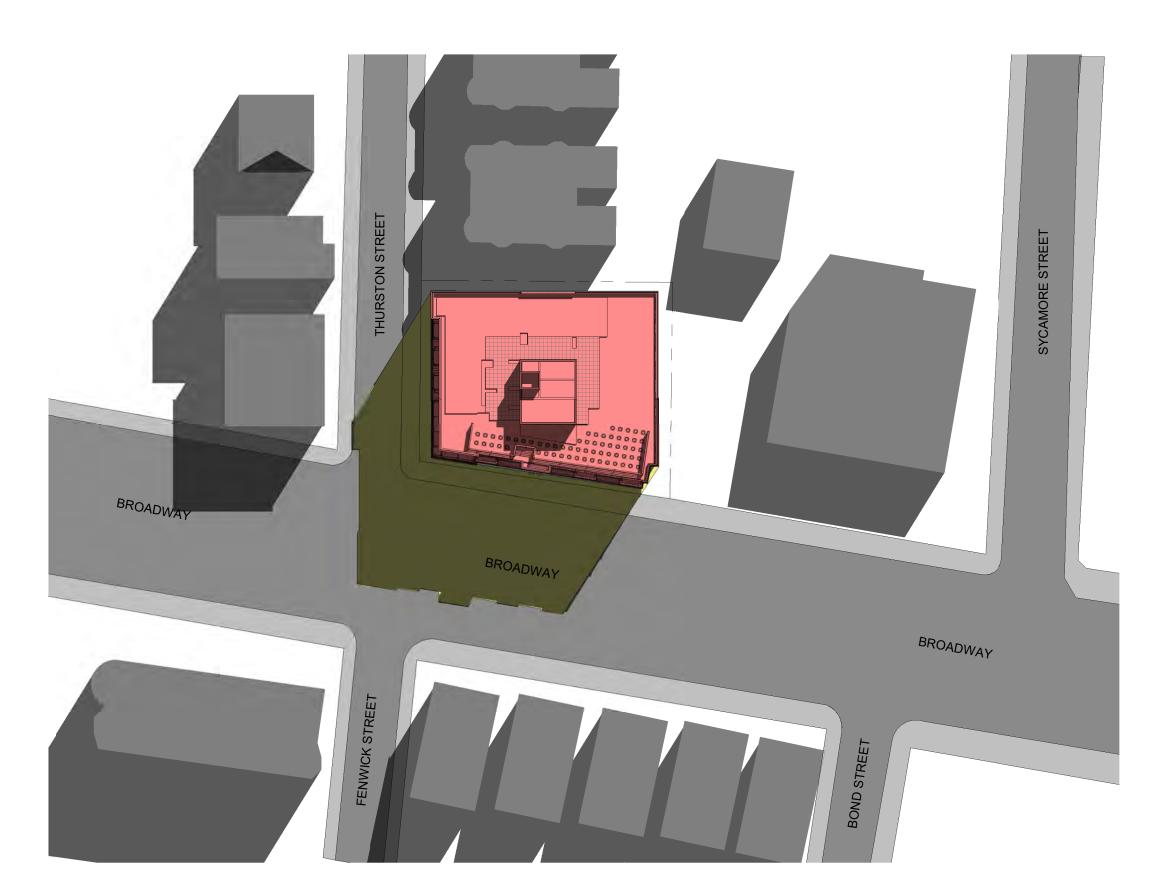
Proposed Aerial

AV-7 366 Broadway Residences


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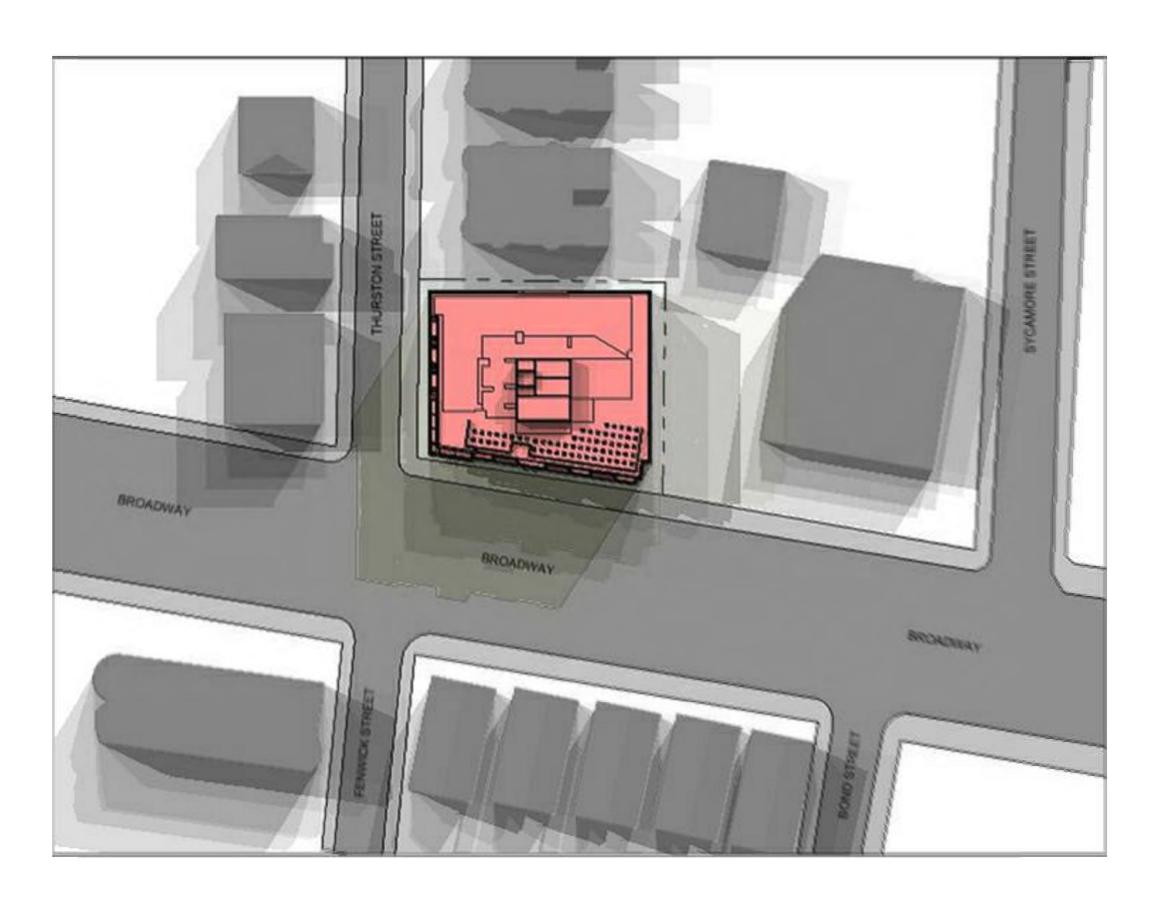
3 PM



12 PM



CUMULATIVE (HOURLY 9AM - 3PM)

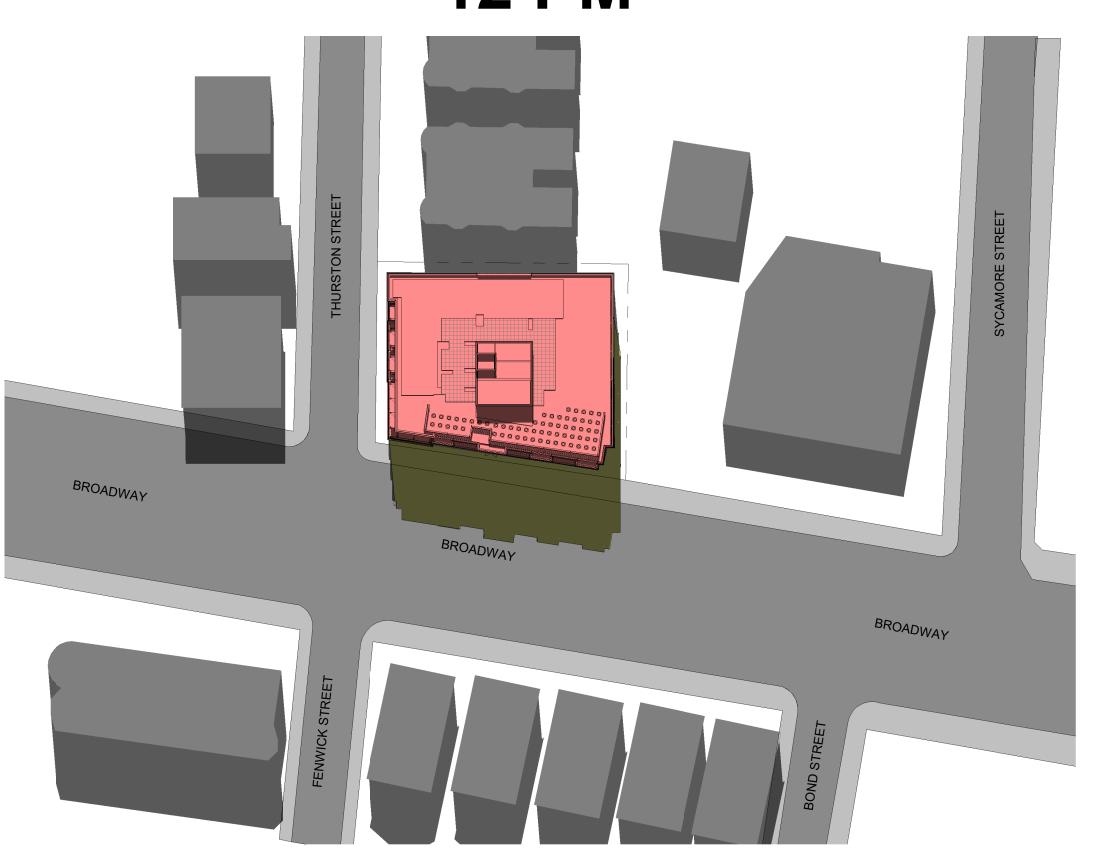

PROJECT NAME

366 Broadway Residences

PROJECT ADDRESS

366 Broadway Somerville, MA

CLIENT

366 Broadway Somerville LLC

ARCHITECT



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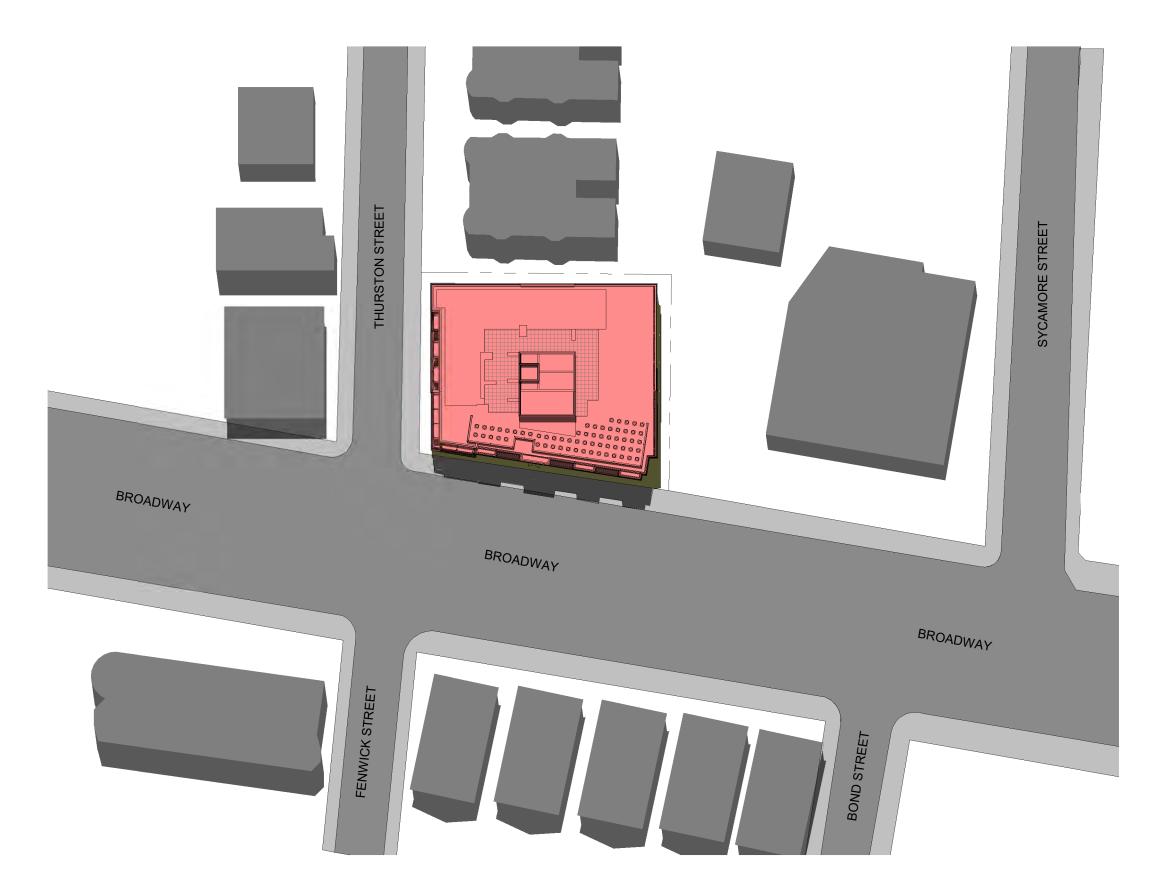
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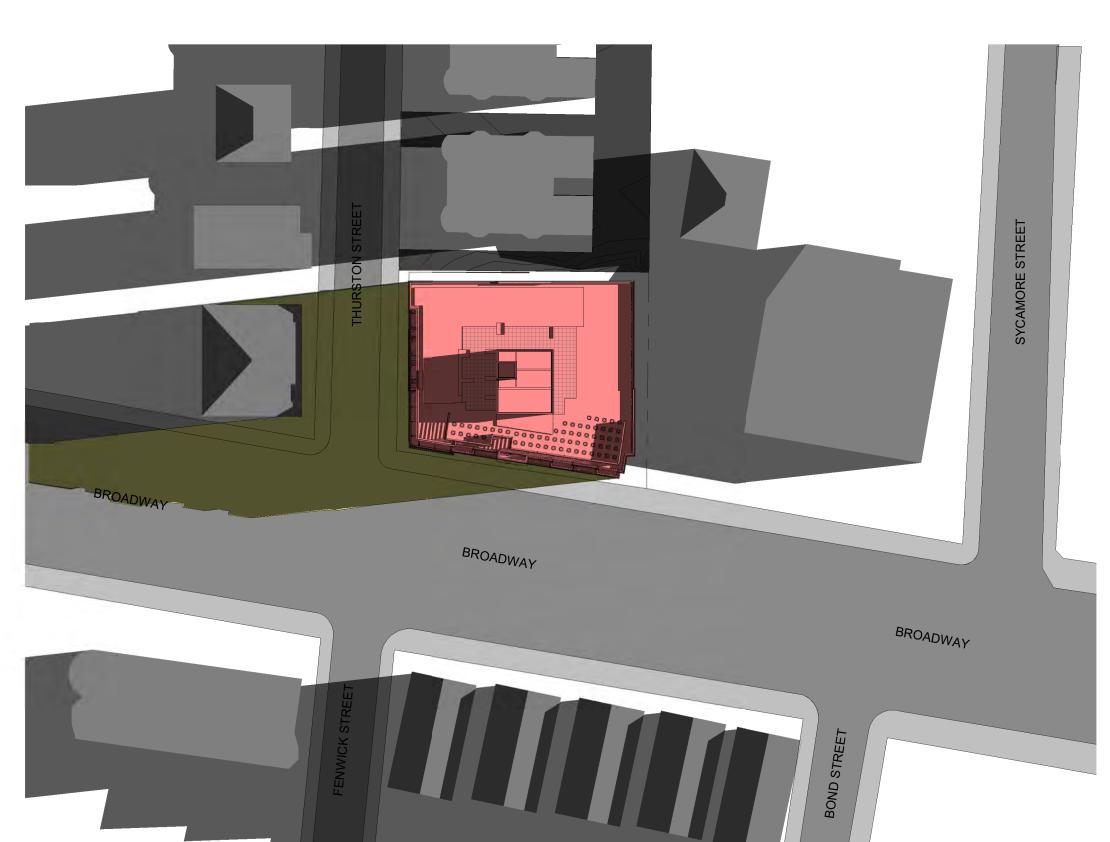
Shadow Study -Vernal Equinox

AV-8
366 Broadway Residences


SUMMER SOLSTICE (JUNE 21)




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PROJECT NAME

366 Broadway Residences

PROJECT ADDRESS

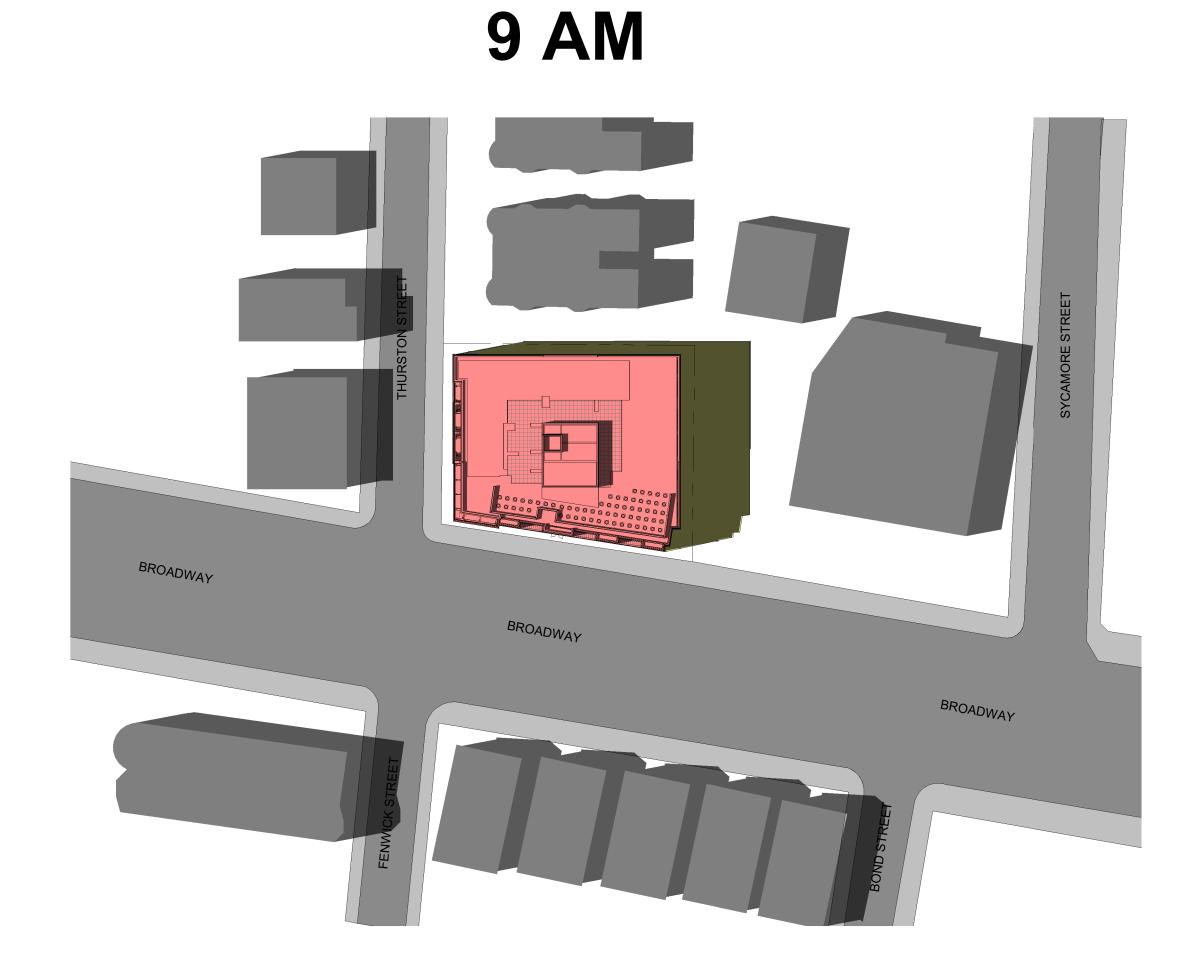366 Broadway Somerville, MA

CLIENT

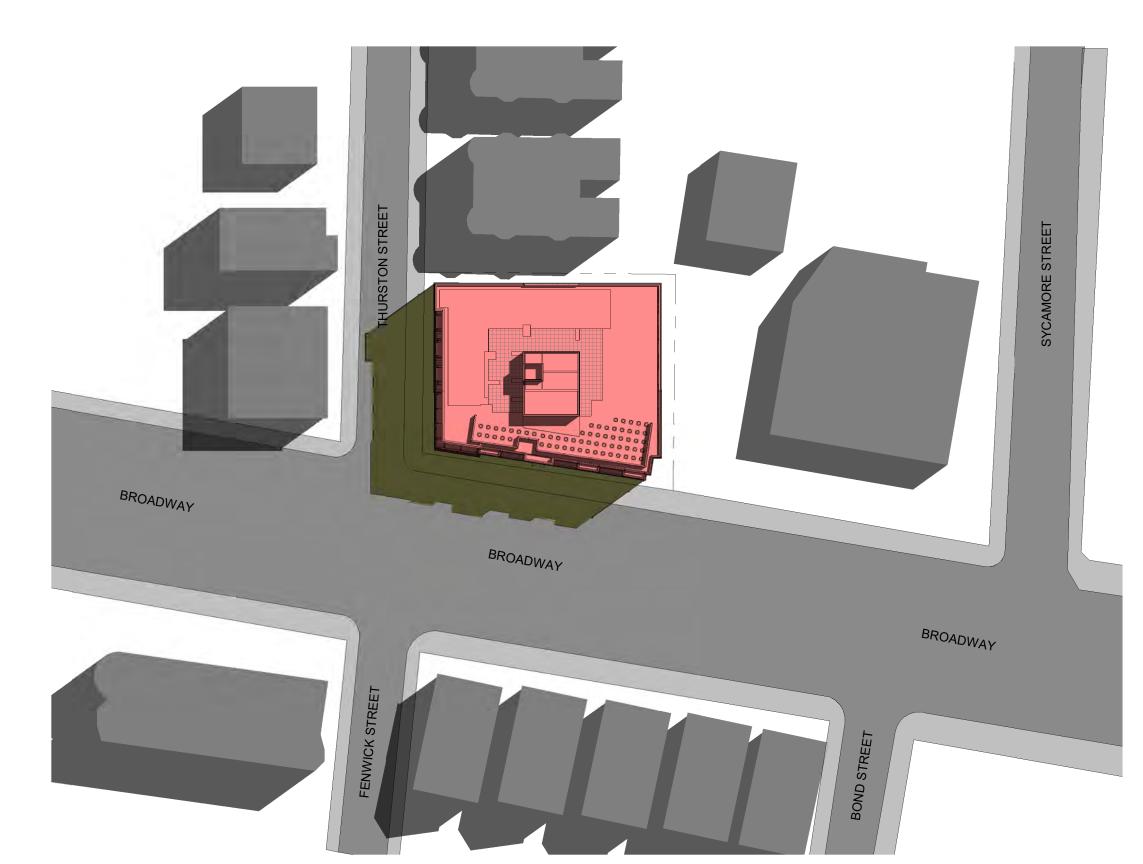366 Broadway Somerville LLC

ARCHITECT



17 IVALOO STREET SUITE 400 SOMERVILLE, MA 02143 TELEPHONE: 617-591-8682

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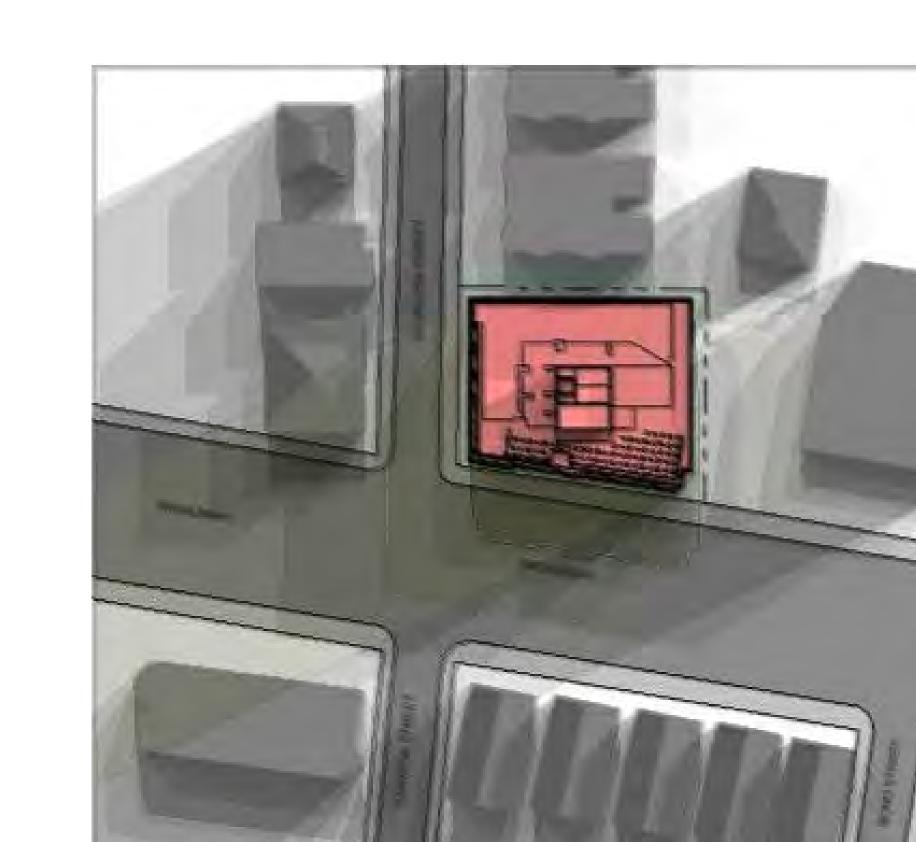
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Date		07/26/2023
Drawn by	1	Author
Checked	by	Checker
Scale		As indicated
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Shadow Study -Summer Solstice

AV-9 366 Broadway Residences CUMULATIVE (HOURLY 9 AM - 6PM)

AUTUMNAL EQUINOX (SEPTEMBER 21)

CUMULATIVE (HOURLY 9 AM - 6PM)



PROJECT NAME

366 Broadway Residences


PROJECT ADDRE

366 Broadway Somerville, MA

CLIENT

366 Broadway Somerville LLC

ARCHITECT

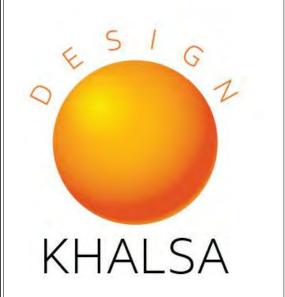

17 IVALOO STREET SUITE 400 SOMERVILLE, MA 02143 TELEPHONE: 617-591-8682

CONSULTANTS:


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Shadow Studies
-Summer Solstice
/Autumnal Equinox


AV-10
366 Broadway Residences




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AUTUMNAL EQUINOX (SEPTEMBER 21)


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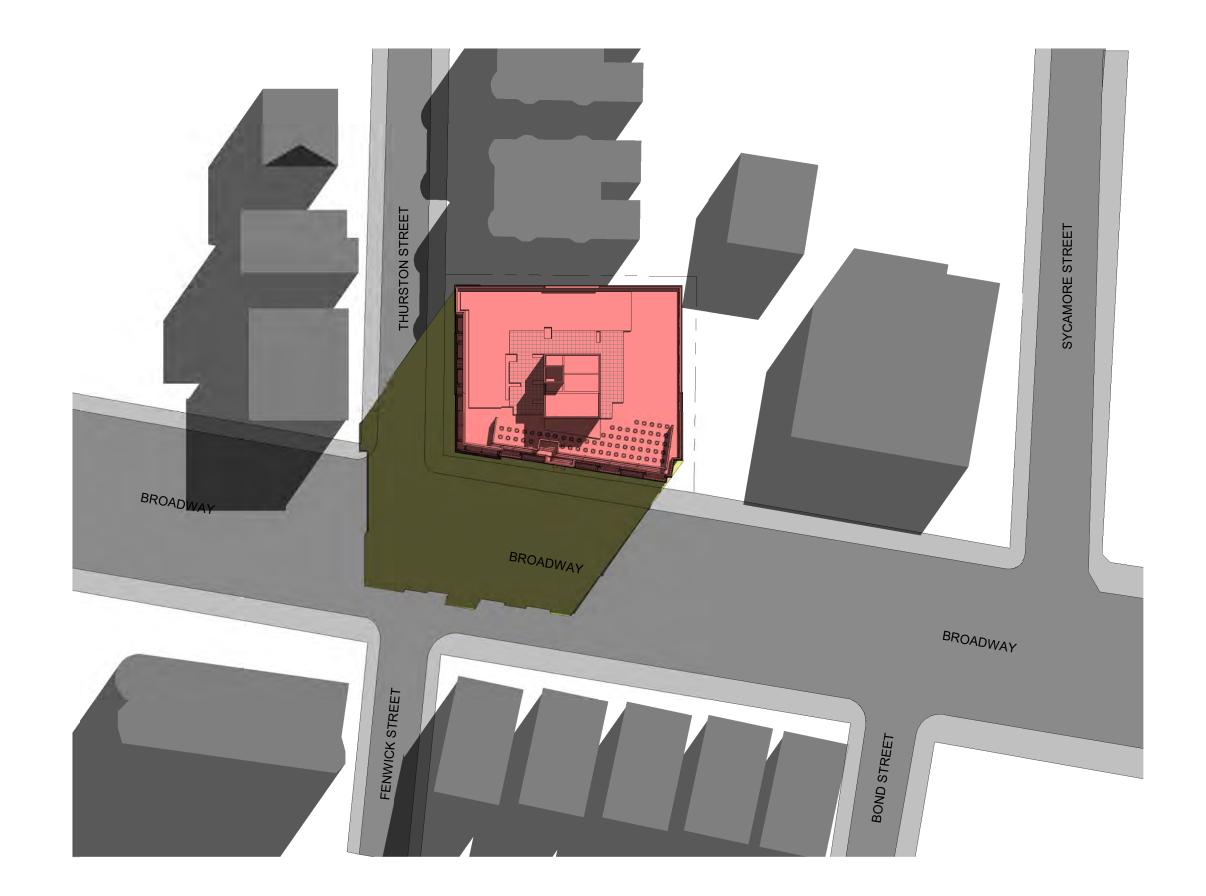

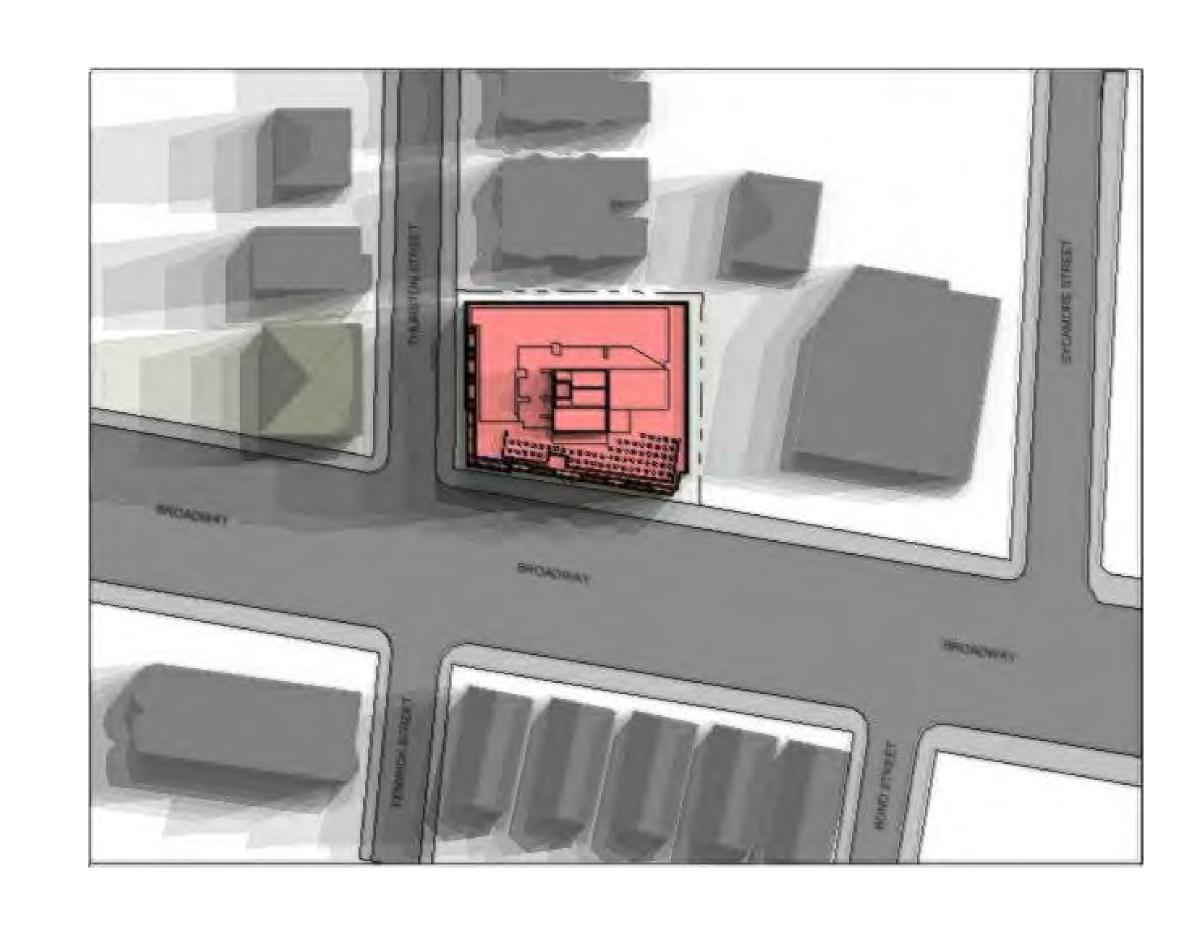
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PROJECT NAME

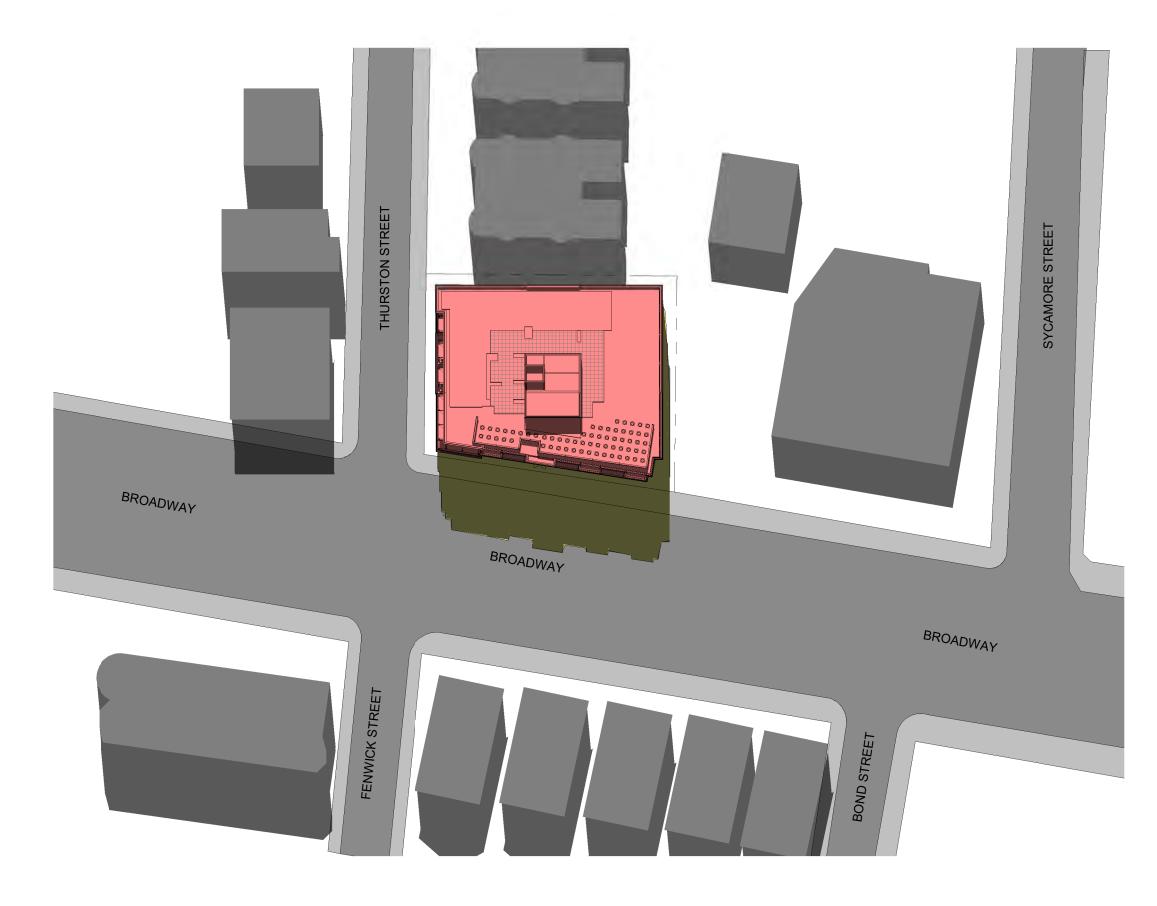366 Broadway Residences

PROJECT ADDRESS

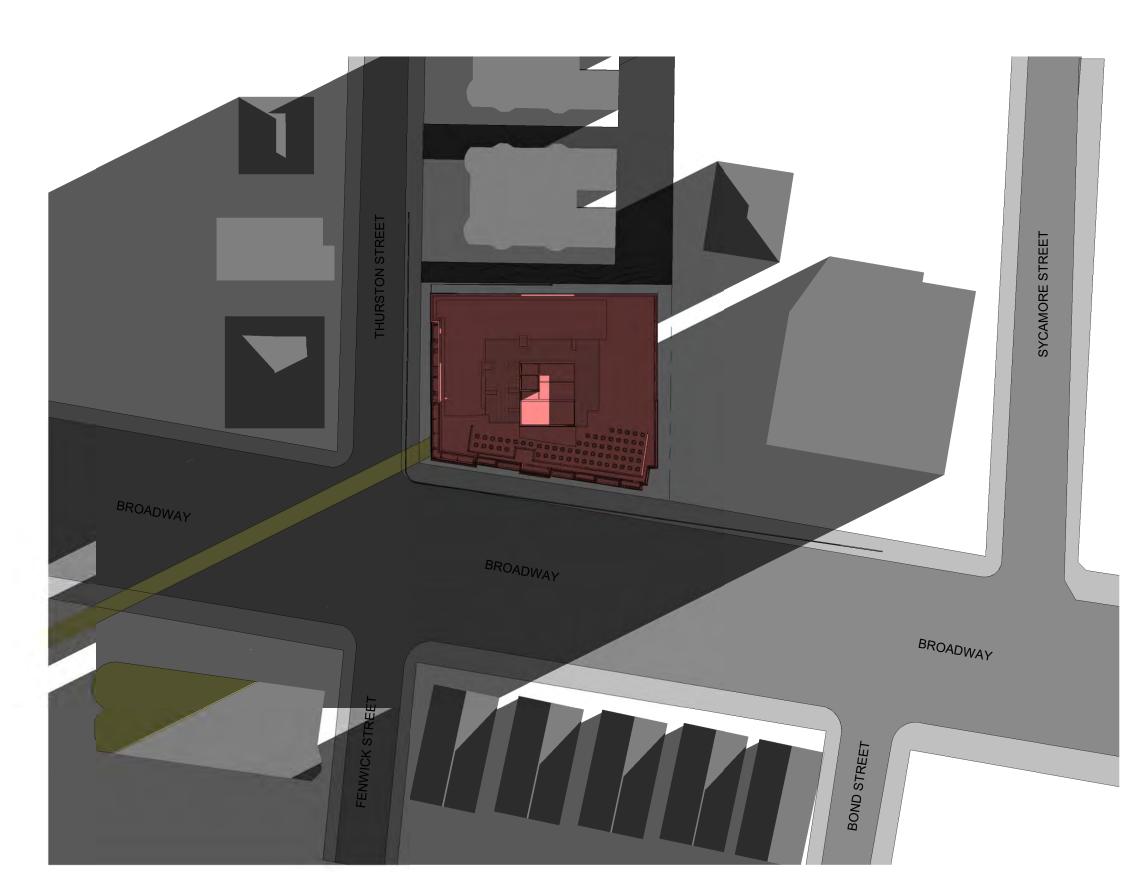366 Broadway Somerville, MA

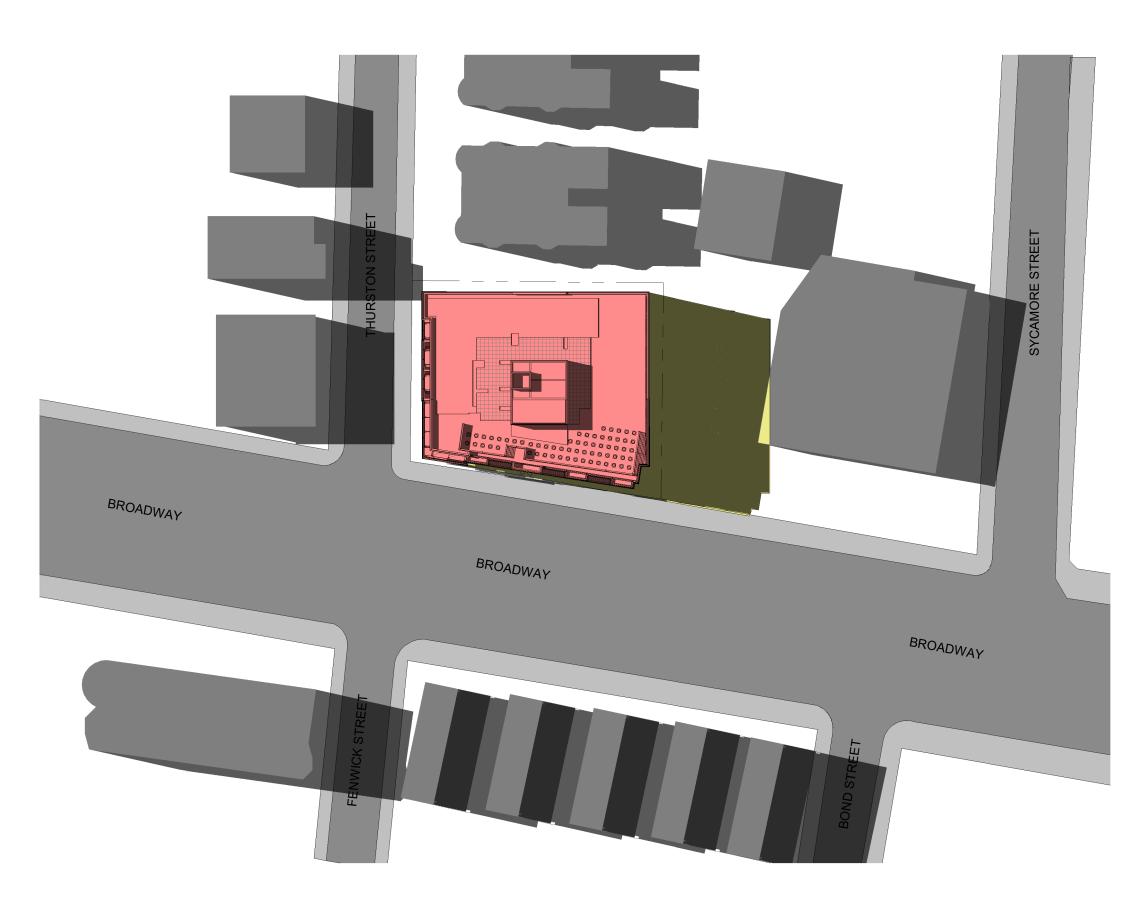CLIENT

366 Broadway Somerville LLC

ARCHITECT



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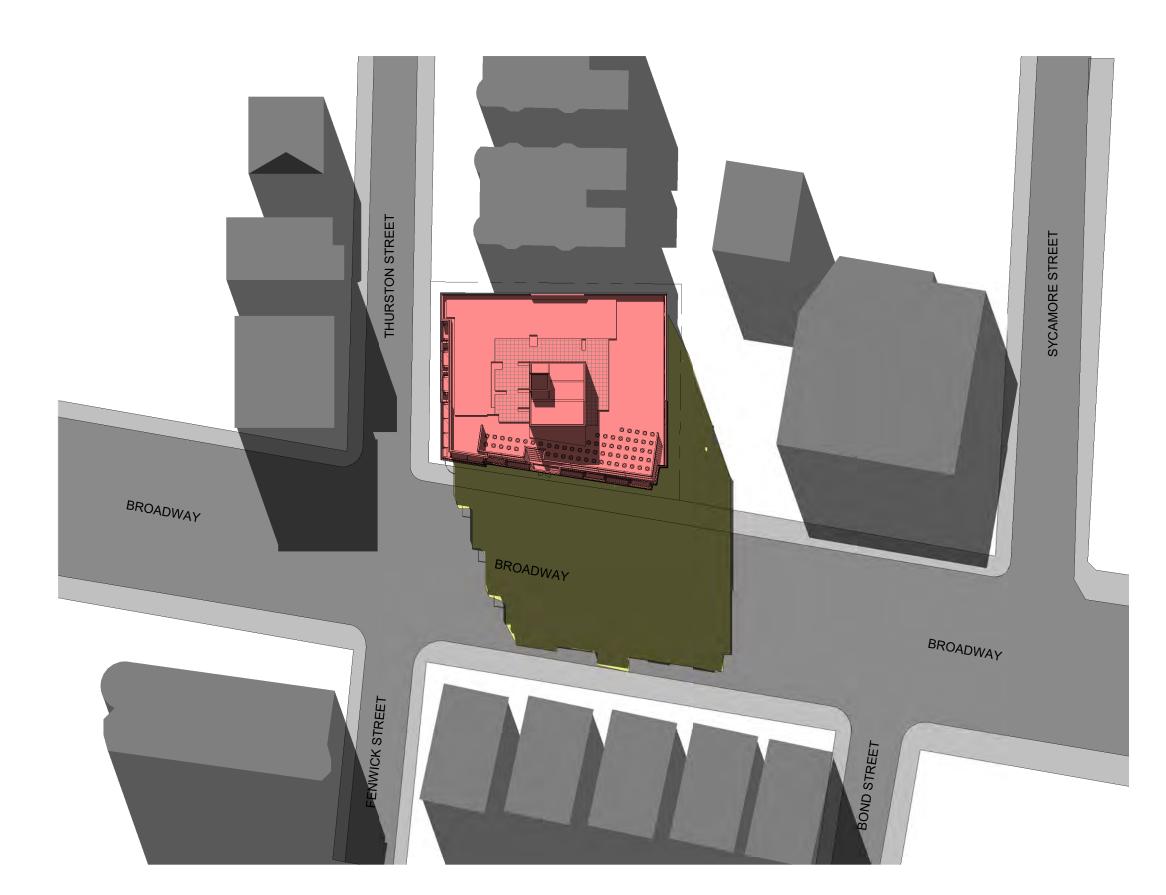
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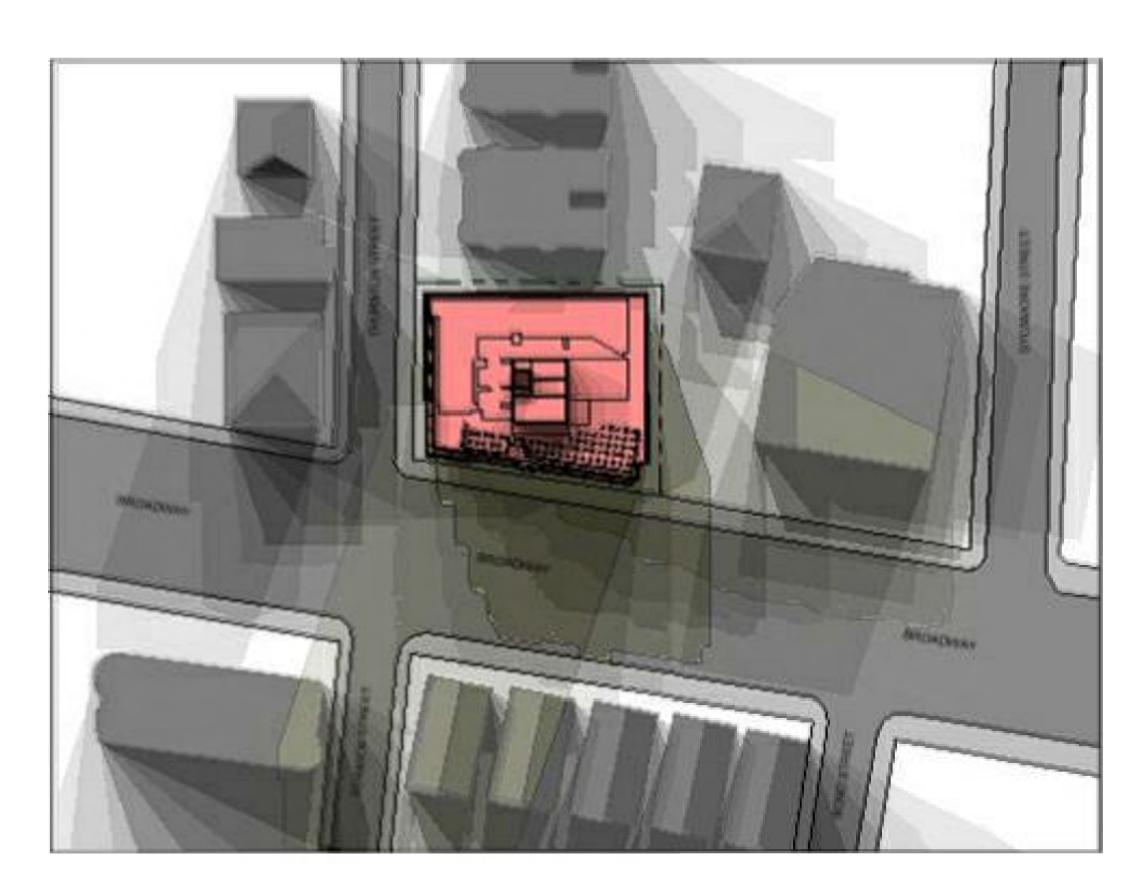
Shadow Studies
-Winter Solstice
/Autumnal Equinox

AV-11
366 Broadway Residences


WINTER SOLSTICE (DECEMBER 21)



CUMULATIVE (HOURLY 9 AM - 3PM)




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PROJECT NAME

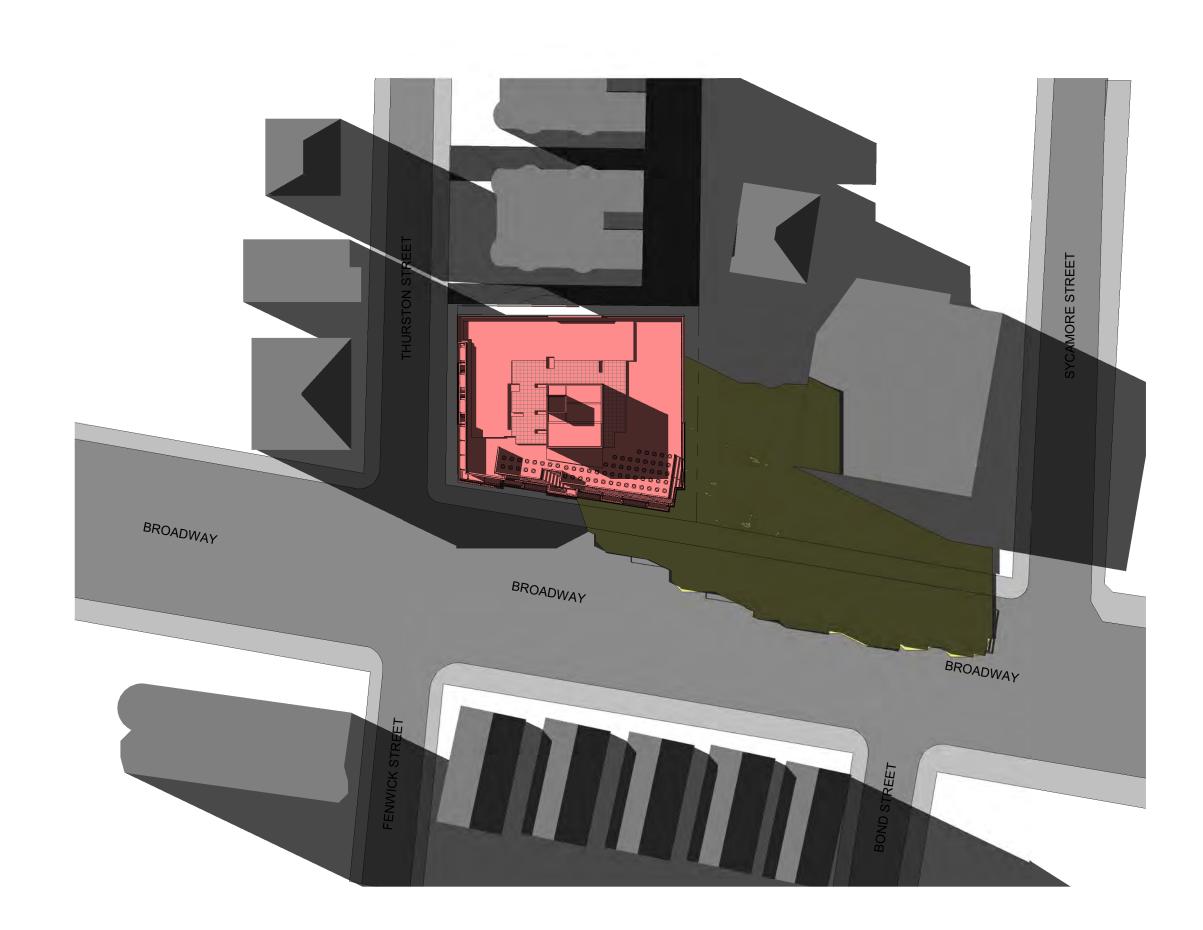366 Broadway Residences

PROJECT ADDRESS

366 Broadway Somerville, MA

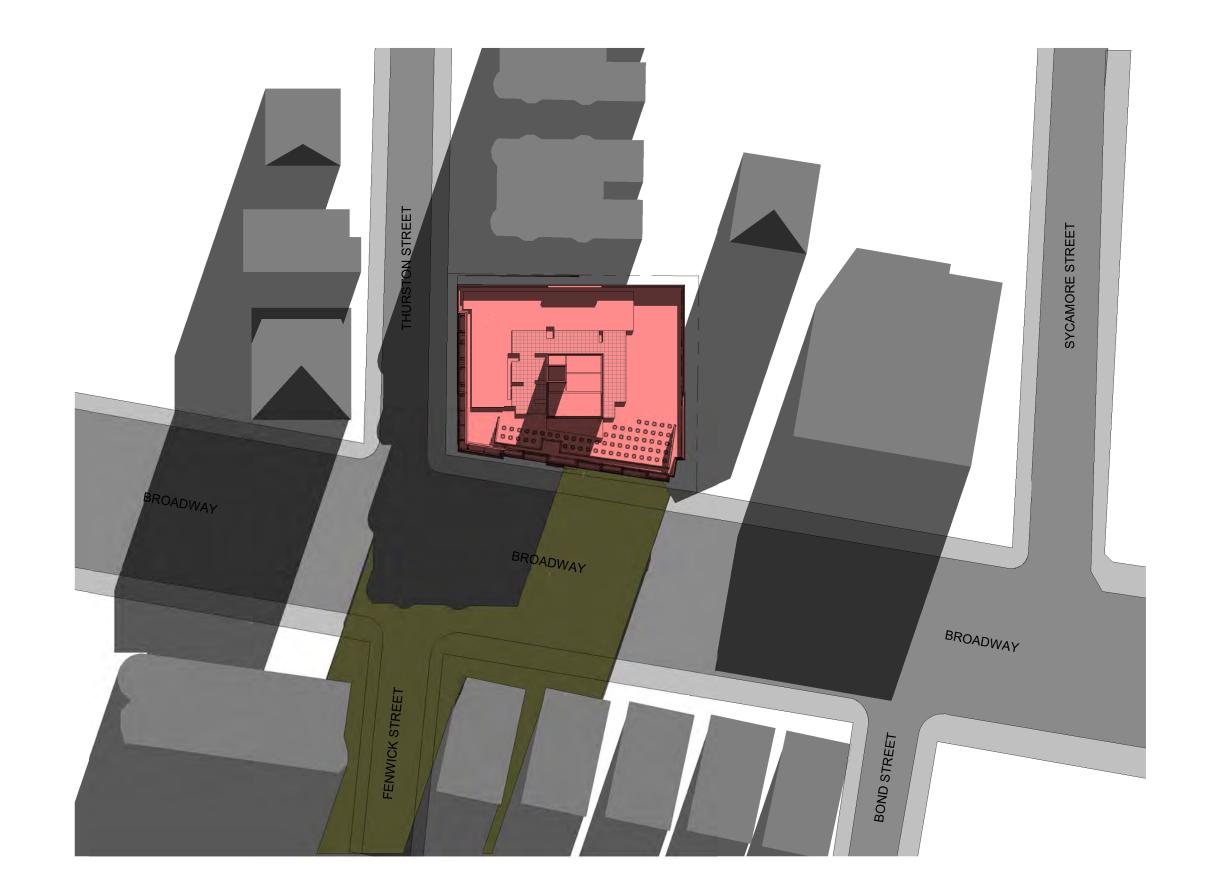CLIENT

366 Broadway Somerville LLC

ARCHITECT



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Winter Solstice Shadow Study

AV-12

366 Broadway Residences

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